MAIN STREET LANDING

RECEIVED

MAY 1 0 2016

DEVELOPMENT DEPARTMENT CITY OF NEW PORT RICHEY

New Port Richey, Florida

Owner:

MAIN STREET LANDING, LLP P.O. BOX 2900 Gainesville, Florida 32602-2900 Phone: (352) 372-6172

Architect/Engineer:

SPRING ENGINEERING, INC. 3014 U.S. Highway 19 Holiday, Florida 34691 (727) 938-1516 Roland P. Dove, P.E.

Surveyor:

BSI & ASSOCIATES 1628 DALE MABRY HIGHWAY SUITE 106 LUTZ, FLORIDA 33548 Phone: (813) 948-6020



Index of Drawings:

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C2.2 Site Plan and Elevations C3.0 Paving, Grading & Drainage Plan

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C3.2 Construction Surface Water Management Plan

C4.0 Utility Plan

C4.1 Utility Details

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Color Elevations

Bldg-2 Color Elevations

Color Elevations Color Elevations

ISSUE DATE: 02-23-16

• LAND PLANNING • ARCHITECTURE WY 19, HOLIDAY, FL (727) 938-1516

New Port Richey, Florida



TITLE SHEET

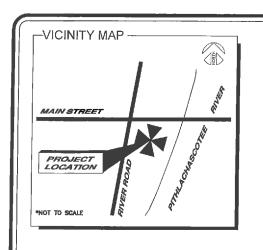
DESIGNED BY: JPE DRAWN BY: JPE CHECKED BY: RPD NUMBER 2004-26

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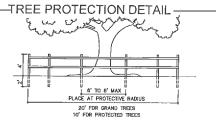


SPRING ENGINEERING, INC.

ARCHITECTURE • ENGINEERING • LAND PLANNING 3014 U.S. HWY. 19, HOLIDAY, FL. (727) 938-1516



SECTION 5, TOWNSHIP 26 SOUTH, RANGE 16 EAST PASCO COUNTY, FLORIDA

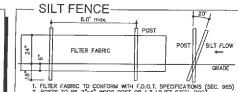


VERTICAL MEMBERS TO BE 2"x2" WOOD STAKES.
 HORIZONTAL MEMBERS TO BE 1"x4" WOOD OR APPROVED SUBSTITUTE.
 PLACE PROTECTIVE BARRIER AT DRIPLINE OR PER LOCAL COOE.

-SIGNATURE FOR CSWMP-

THIS IS TO CERFITY THAT THE OWNER/AGENT IS AWARE AND ASSURES MAINTENANCE OF EROSION PROTECTION THAT IS ASSOCIATED WITH THIS PROJECT DURING CONSTRUCTION

SIGNITURE OF OWNER OR AUTHORIZED AGENT PURSUANT TO SEC. 2.8.4.6 OF B.O.R. PETER ALTMAN, OWNER



1. FILER FABRIC TO CONFORM WITH F.D.O.T. SPECIFICATIONS (SEC. 2. POSTS TO BE 2"x-4" WOOD POST OR 1.3 LB/FT STEEL POST. 3. POST POSTION TO BE CANTED (20') OR VERTICAL (90').

4. DO NOT DEPLOY IN A MANNER THAT SILT FENCE WILL ACT AS A DAM ACROSS PERMANENT FI OWNER WATERONINGS.

-NOTES-

1. THE CONTRACTOR SHALL DEMOUSH, REMOVE AND DISPOSE OF EXISTING BUILDINGS, PAVEMENT, SIDEWALKS, FENCES, POWER POLES & OVERHEAD LINES LIGHT POLES, SEWER AND WATER LINES, IRRIGATION SYSTEM, SIGNS, ETC. WITHIN THE PROJECT SITE,

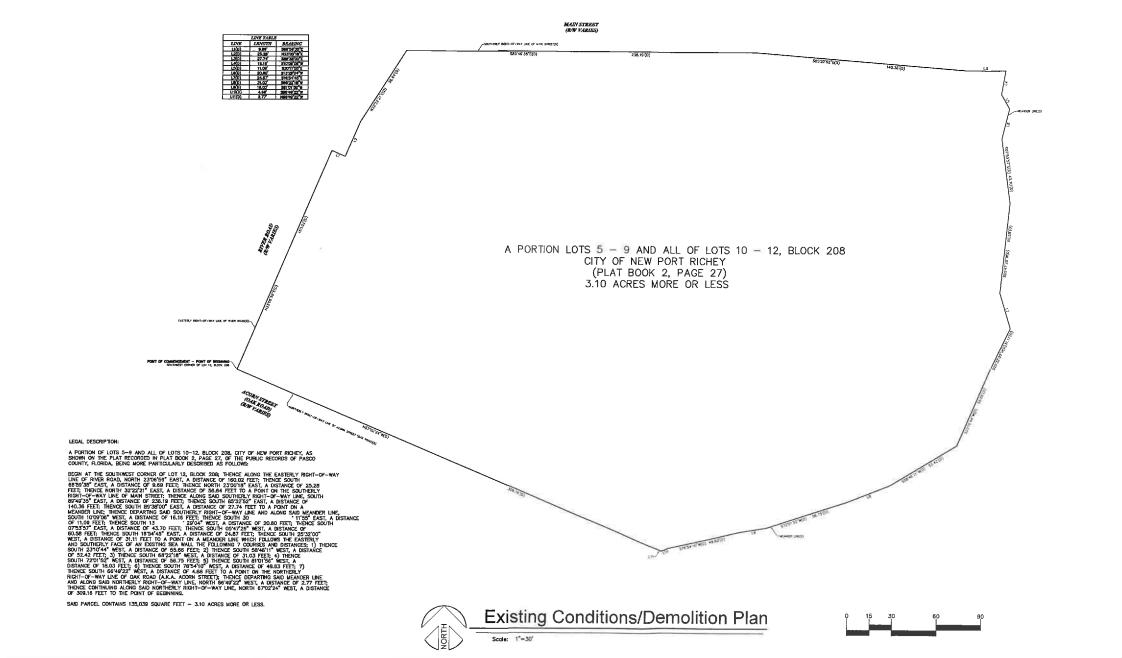
LL DEMOLITION DEBRIS AND REFUSE MATERIALS SHALL BE DISPOSED OF IN ORDANCE WITH ALL APPLICABLE LOCAL CODES AND STATE RULES.

3. THE CONTRACTOR SHALL OBTAIN ALL NECESSARY PERMITS FROM LOCAL AND STATE AGENCIES PRIOR TO PERFORMING DEMOLITION/DISPOSAL WORK.

 PRIOR TO REMOVAL OF ANY UTILITIES IN THE PROJECT SITE (I.E. GAS, WATER, SEWER, ELECTRIC, TELEPHONE) THE CONTRACTOR SHALL CONTACT APPROPRIATE UTILITY COMPANY.

5. PRIOR TO REMOVING EXISTING BUILDINGS THE G.C. SHALL HAVE AN ASSESTOR SURVEY PREPORMED. THE CONTRACTOR SHALL THEN PROCEED AS OUTLINED IN THE WRITTEN SURVEY REPORT.

6. THE INFORMATION CONTAINED ON THIS EXISTING CONDITION PLAN WAS OBTAINED BY SUMMIT SURVEYING SERVICES, INC. AND SPRING ENGINEERING ASSUMES NO RESPONSIBILITY FOR ITS ACCURACY AND/OR ITS COMPLETENESS.



THIS DRAWING AND THE DESIGN SHOWN ARE THE PROPERTY OF SPRING ENGINEERING, INC. AND ARE NOT TO REPRODUCED, COOPIED, THE PROPERTY OF THE NOTION OF THE STREET OF THE STREE P. DONG, P.E.

No. 38833

DATE

DESCORPTION

P. DONG, P.E.

No. 38833

CONSTRUCTION DOC'S

IN STREET LANDING

New Port Richey, Florida

CONTRACT DATE:
July 20, 2004

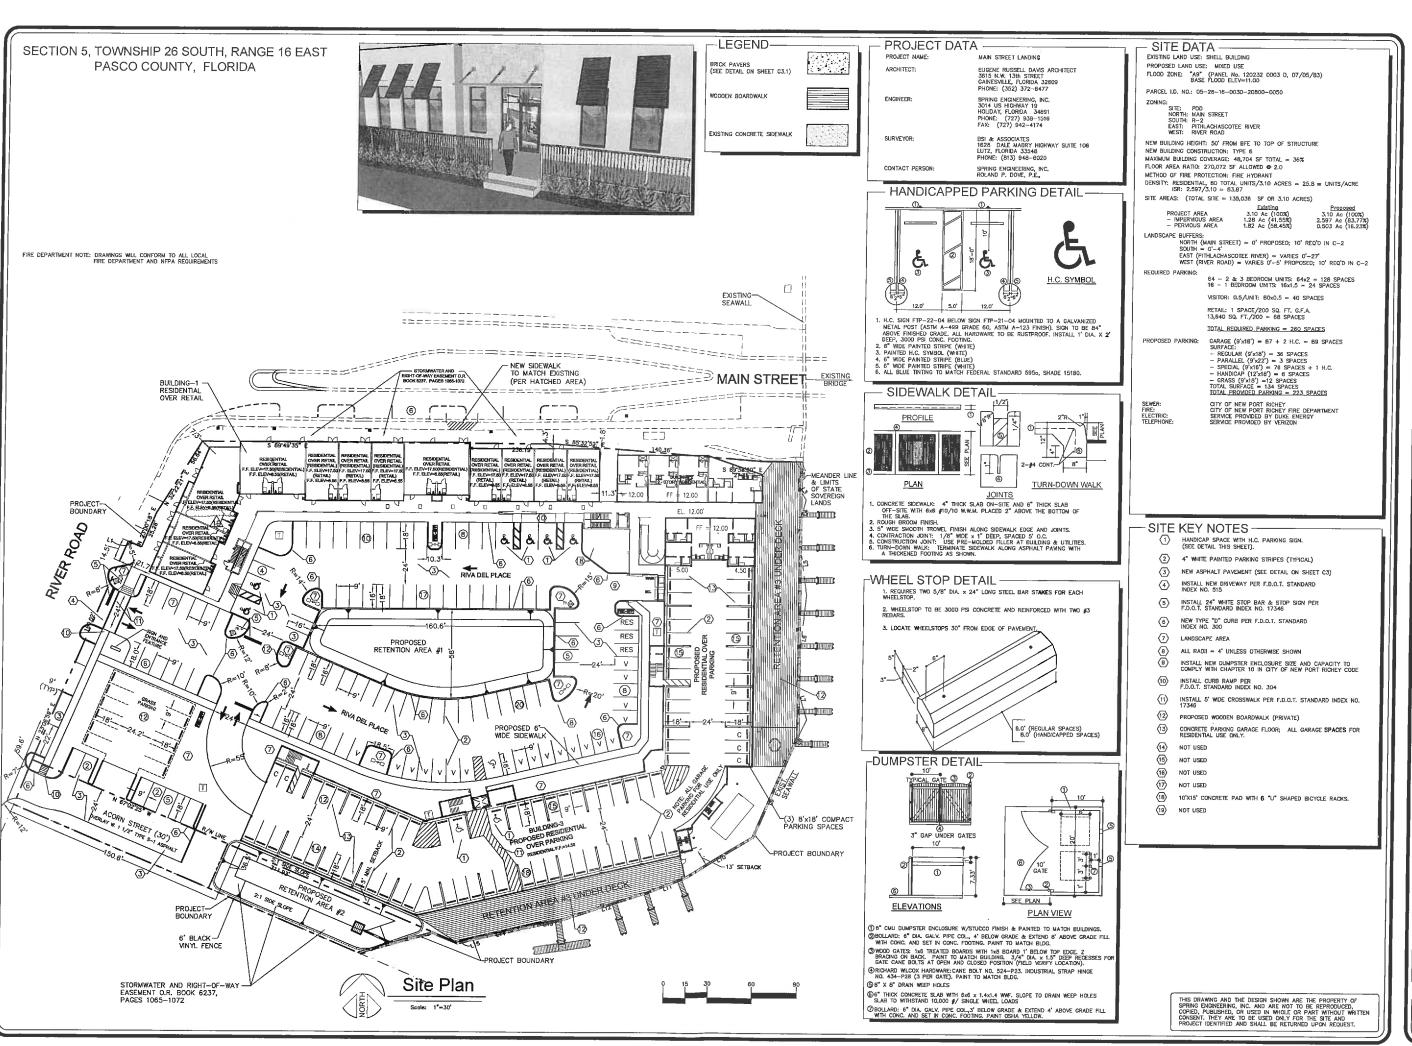
SPRING ENGINEERING, INC. NGINEERING ARCHITECTURI O14 U.S. HWY 19, HOLIDAY, FL (727) 938–1511 P. COA NO. 00005188 & LICENCE NO. AA-C00147

EXISTING CONDITIONS/ DEMOLITION PLAN

DESIGNED BY: JPE
DRAWN BY: JPE
CHECKED BY: RPD

IOB NUMBER 2004-26

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NSTRUCTION DOC'S SSUE DATE: 02-23-16

STREET LANDING Florida Port Richey, New MAIN

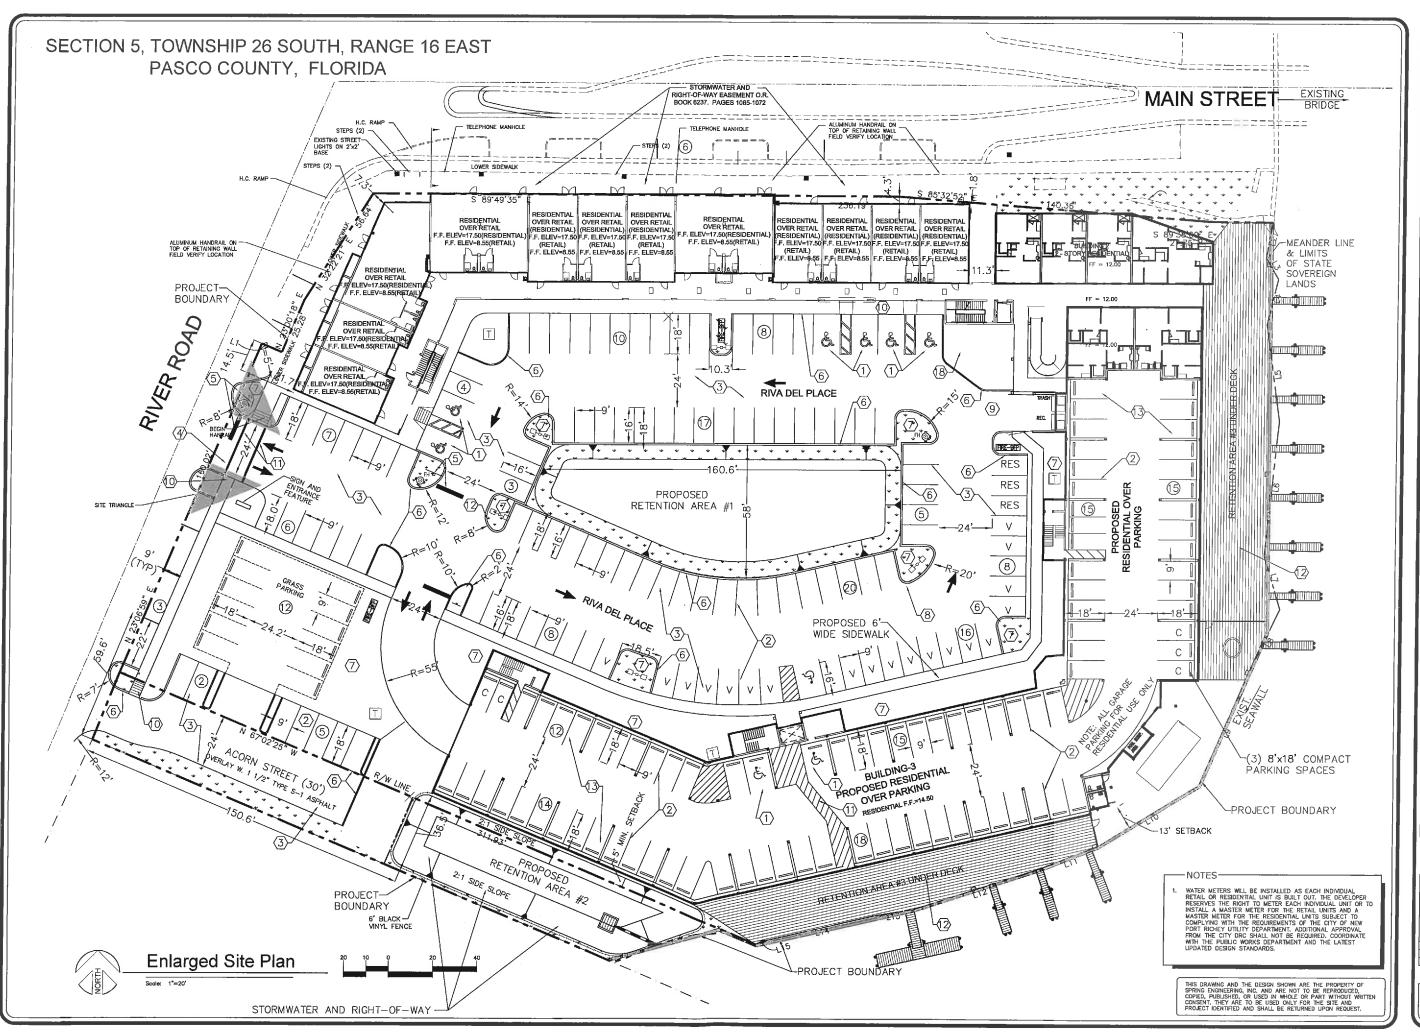
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> NC. ENGINEERING, S. HWY COA NO. SPRING

DRAWN BY: JPE CHECKED BY: RPD

JOB NUMBER 2004-26

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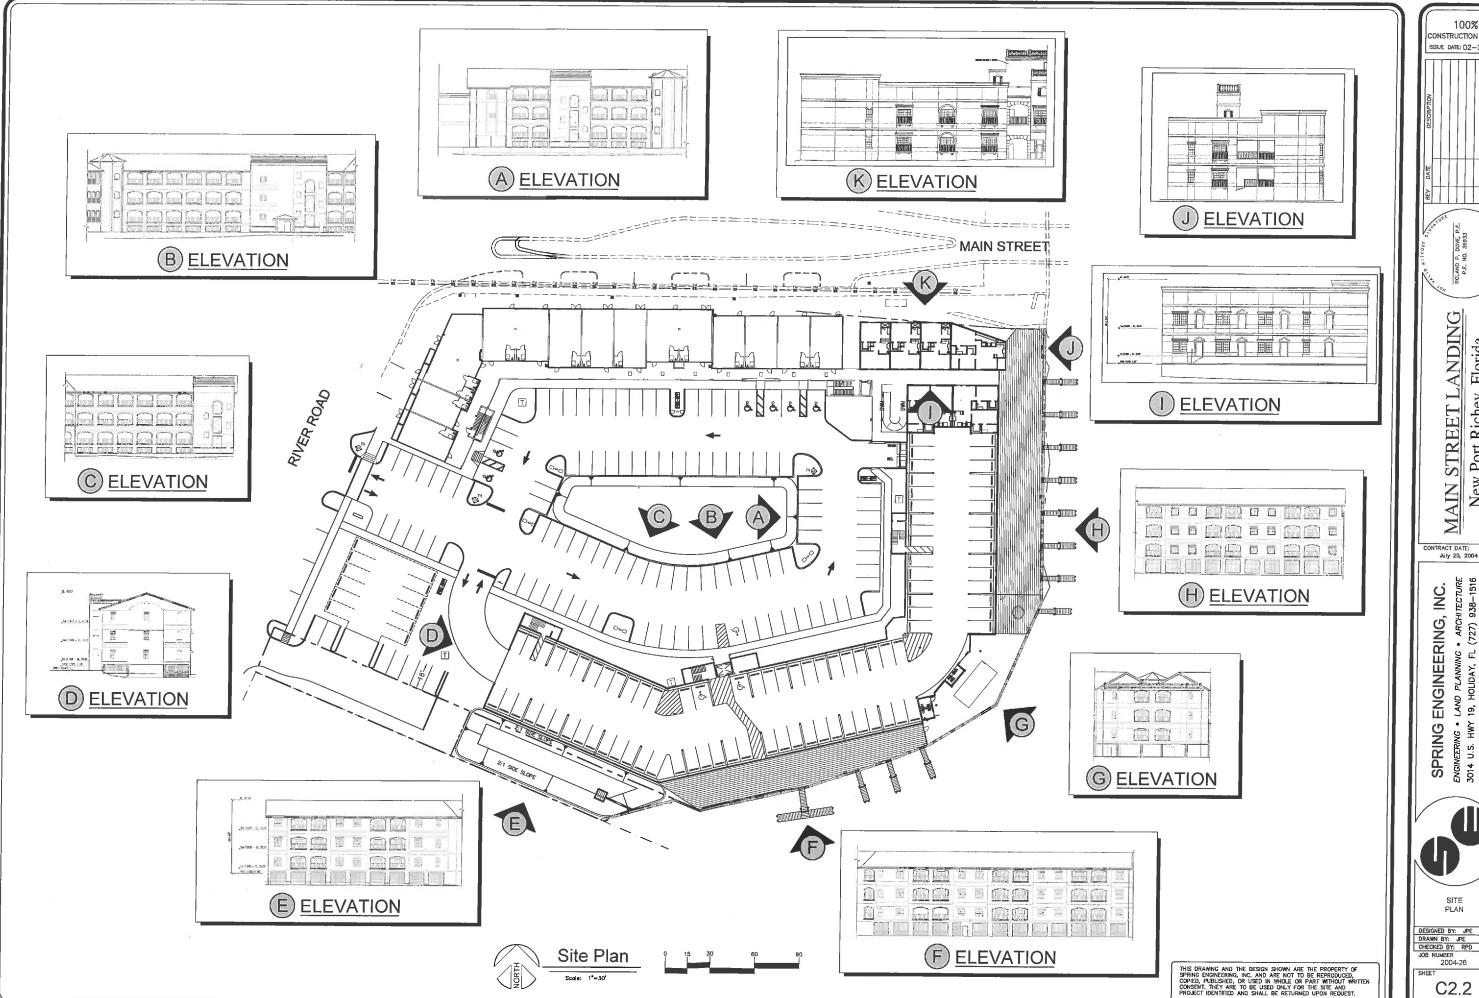


ONSTRUCTION DOC'S SSUE DATE: 02-23-16 MAIN STREET LANDING New Port Richey, Florida CONTRACT DATE: July 20, 2004 SPRING ENGINEERING, INC.
NGINEERING - LAND PLANNING - ARCHITECTUR
6014 U.S. HWY 19, HOLIDAY, FL (722) 938-151
FL COA NO. 000005188 & LICENEE NO. AN-COOTAT

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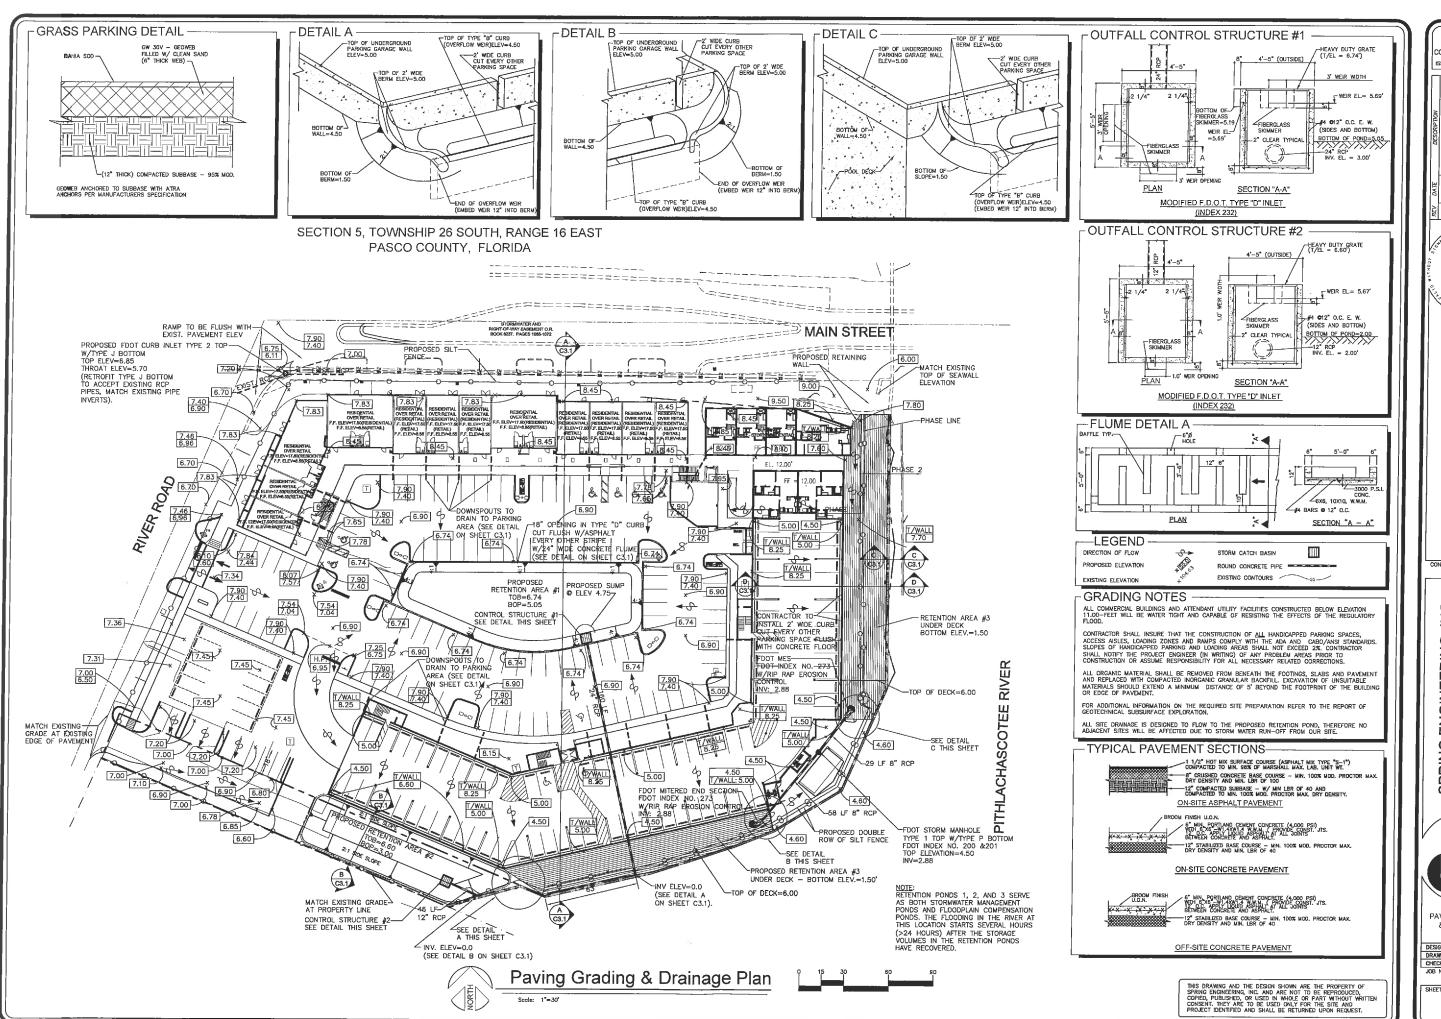
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MAIN STREET LANDING
New Port Richey, Florida

SPRING ENGINEERING, INC.
ENGINEERING • LAND PLANNING • ARCHITECTURE
3014 U.S. HWY 19, HOLIDAY, FL (727) 938-1516
P. COA NO. 00005168 & LICENCE NO. AA-C00774

DESIGNED BY: JPE
DRAWN BY: JPE
CHECKED BY: RPD
JOB NUMBER
2004-26

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ANDING Florida Port Richey, STREETI New AIN

CONTRACT DATE:

July 20, 2004

NC. ENGINEERING,

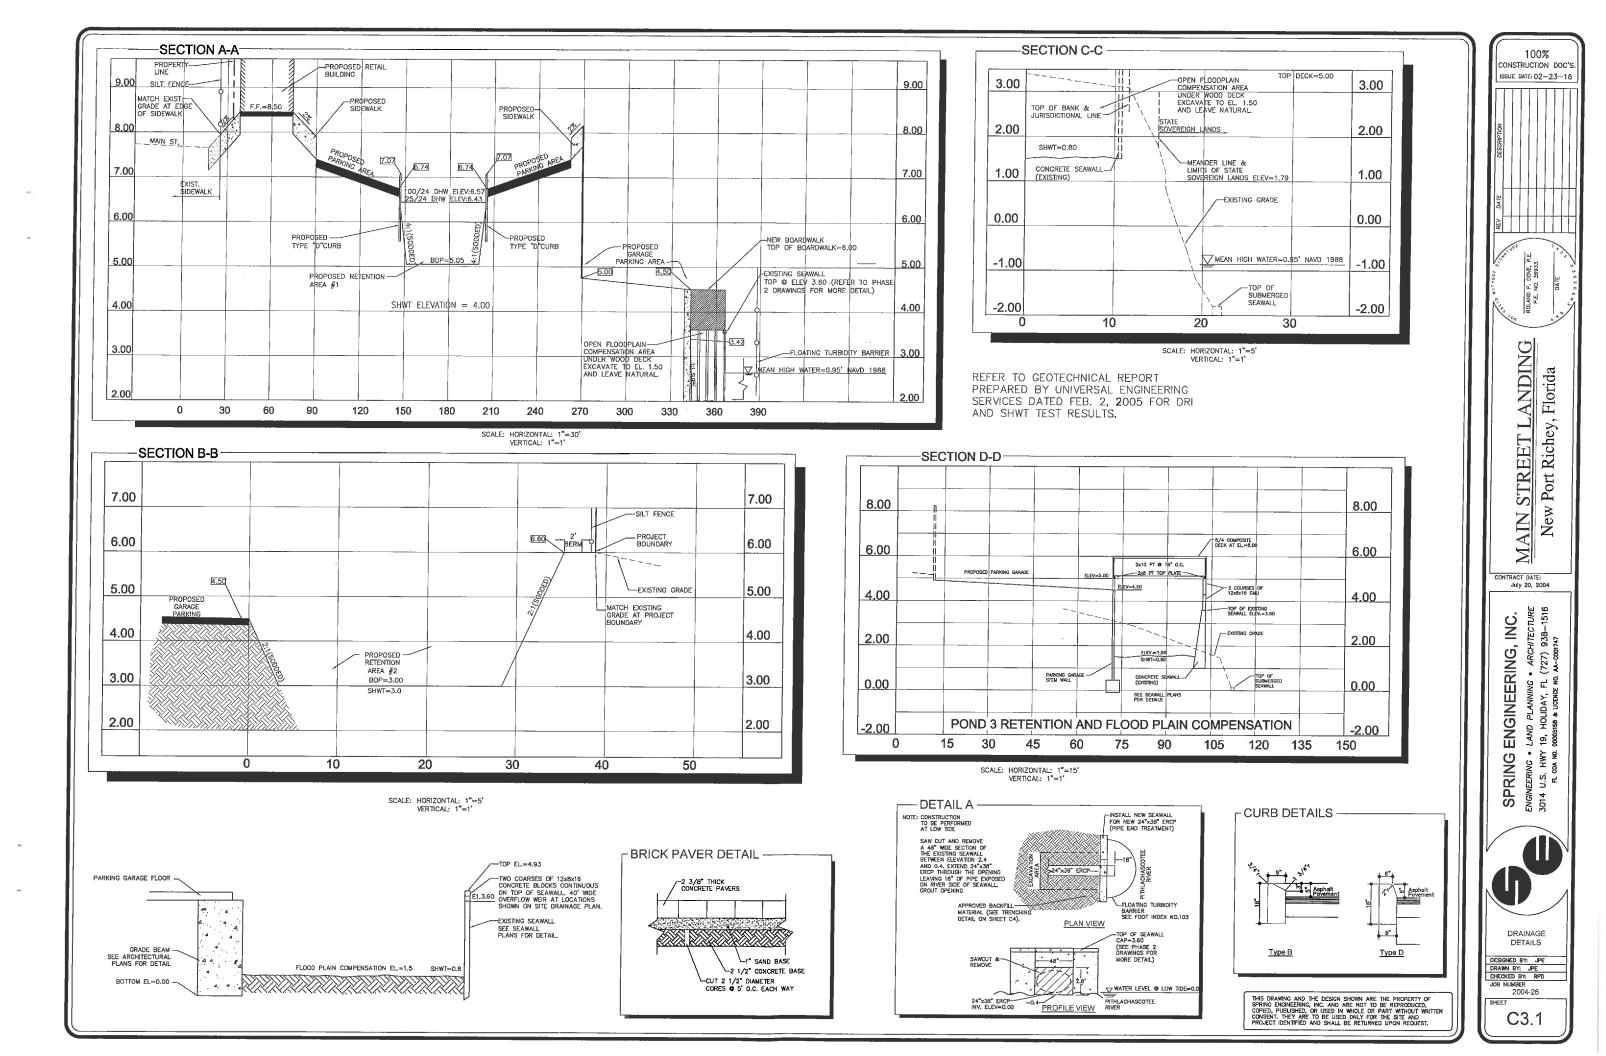
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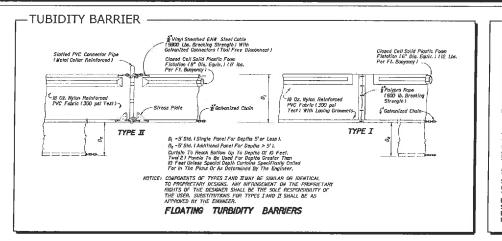
PAVING GRADING & DRAINAGE

PLAN RAWN BY: JPE

CHECKED BY: RPD JOB NUMBER 2004-26

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ALL WORK ALONG MAIN STREET AND RIVER ROAD TO BE CONSTRUCTED PER CITY OF NEW

CONTRACTOR SHALL INSTALL—SILT FENCE ALONG PROPERTY LINE PER DETAIL ON THIS SHEET

RIVER ROAD

CONTRACTOR SHALL INSTALL—SILT FENCE ALONG PROPERTY
LINE PER DETAIL ON THIS SHEET

STORGHAMTER AND PROPERTY LINE PER DETAIL ON THIS SHEET

MAIN STREET

MAIN STREET

-EROSION CONTROL —

TREE BARRICADES AND EROSION CONTROL: ALL EROSION CONTROL MEASURES (SILT BARRIERS) AND TREE BARRICADES MUST BE INSTALLED PRIOR TO THE START OF CONSTRUCTION AND REMAIN IN PLACE THROUGHOUT CONSTRUCTION. ENFORACEMENT OF FALURE TO MAINTAIN THESE BARRICADES COULD RESULT IN ENFORCEMENT ACTION WHICH MAY INCLUDE CITATIONS AND/OR PERMIT REVOCATION. SILTATION BARRIERS SHALL BE MAINTAINED AND REPARED AT THE BND OF EACH WORKING DAY. HAY BALES SHALL BE INSTALLED ONCE PERMIETER GRADING IS COMMETTED. STORMWATER FACILITIES SHALL HAVE HAY BALES SHALL BE INSTALLED AND THE ENTRANCES TO PREVENT SEDIMENT FROM BEING TRANSPORTED INTO THE STORMWATER SYSTEM. HAY BALES SHALL BE PLACED ALONG THE PERMIETER OF ALL DOWNSTREAM BOUNDAINES TO PROVIDE FILTRATION OF RUNOFF DURING CONSTRUCTION. THE HAY BALES SHALL REMAIN IN PLACE UNTIL THE ENGINEER HAS APPROVED THE VECETATIVE COVER ALONG EMBANKMENTS PROVIDING RUNOFF TO THE PERMIETER ITS THE CONTRACTOR'S RESPONSIBILITY TO MAINTAIN SOIL EROSION CONTROL DEVICES. IF AT ANY TIME DRAINAGE STRUCTURES OR EROSION CONTROL DEVICES BECOME DAMAGED OR INOPERABLE, IT IS THE CONTRACTORS RESPONSIBILITY TO REPAIR THEM.

THE CONTRACTOR IS EXPECTED, AT THE END OF EACH DAY, TO HAVE THE SITE GRADED IN SUCH A WAY THAT ADJACENT PROPERTIES ARE NOT ADVERSELY IMPACTED BY ENGSION OR SEDIMENT LEAVING THE SITE, CLEARED AREAS SHALL BE STABILIZED EARLY IN THE CONSTRUCTION PROCESS AND IF NATURAL PREPERITATION DOES NOT PROVIDE PREPIODIC WEITING OF THE SITE, THEN THE CONTRACTOR SHALL PROVIDE A METHOD OF SPRAYING THE SITE TO PREVENT WIND EROSION, CONTRACTOR SHALL CLEAR ONLY THAT JAREA SHOWN TO BE CLEARED ON THE PLAN. CARE SHALL BE TAKEN TO DISTURB THE EXISTING VEGETATION IN ONLY THOSE AREAS UNDER CONSTRUCTION AT THAT TIME.

ALL CLEAR S STE AREAS SHALL BE KEPT FREE OF ANY SIGNAGE, PLANTINGS, TREES, ETC. IN EXCESS OF THREE—AND—A—HALF (3 1/2) FEET IN HEIGHT. DURING LAND ALTERATION AND CONSTRUCTION ACTIVITIES, IT SHALL BE UNLAWFUL TO REMOVE VEGETATION BY GRUBBING OR TO PLACE SOIL DEPOSITS, DEBRIS, SOLVENTS, CONSTRUCTION MATERIAL, MACHINERY OR OTHER EQUIPMENT OF ANY KIND WITHIN THE DRIP LINE OF A TREE TO REMAIN ON THE SITE UNLESS OTHERWISE APPROVED BY THE LOCAL GOVERNMENT. ALL TREE ROOTS EXISTING WITHIN APPROVED IMPROVEMENT AREAS AND ORIGINATING FROM A PROTECTED TREE SHALL BE SEVERED CLEAN AT THE LIMITS OF THE PRESERVED AREA. ALL TRUMMING UNDERTAKEN ON A TREE PROTECTED BY THE PROVISIONS OF THE LAND DEVELOPMENT CODE SHALL BE PRUNED IN ACCORDANCE WITH THE NATIONAL ARBORIST ASSOCIATION (NAA) PRUNING STANDARDS.

-EROSION CONTROL NOTES -

- THE PERIMETER CONTROLS (SILT FENCE AND HAY BALES) SHALL BE INSTALLED AROUND THE ENTIRE AREA TO BE DISTURBED, AS SHOWN,
- HAY BALES TO BE PROVIDED AROUND THE NEW CATCH BASINS IMMEDIATELY AFTER THE BASINS ARE INSTALLED AND TEMPORARILY REMOVED FOR PAVEMENT INSTALLATION.
- . HAY BALE BARRIERS SHALL BE PROVIDED IN EXISTING UPLAND DITCHES DURING PIPE PLACEMENT AND DITCH FILLING OPERATIONS. SEE DETAIL THIS SHEET.
- 4. WASTE, SUCH AS DISCARDED BUILDING MATERIALS, CHEMICALS, LITTER OR SANITARY WASTE ARE TO BE PROPERLY CONTROLLED AND NOT DISCHARGED TO THE DRAINAGE DITCHES.
- TRUCKING OF SEDIMENTS AND GENERATION OF DUST BY OFF-SITE VEHICLES SHALL BE MINIMIZED.
- PROVIDE TEMPORARY DISTURBED AREA STABILIZATION BY SPREADING RYE GRASS SEED AT THE RATE OF 188 LBS PER ACRE.
- THE APPLICATION, GENERATION AND MIGRATION OF TOXIC SUBSTANCES SHALL BE LIMITED. AND PROPERLY STORED AND DISPOSED OF.
- 8. EROSION CONTROL DEVICES SHALL BE MAINTAINED IN PROPER WORKING ORDER THROUGHOUT THE CONSTRUCTION. MAINTENANCE SHALL BE PERFORMED AS NEEDED. DEVICES SHALL BE REPAIRED AND/OR REPLACED AS REQUIRED. MATERIAL SHALL BE REMOVED WHEN SEDIMENT BUILD-UP REACHES 50% OF THE HEIGHT OF THE DEVICE.
- ONLY SHALL BY A STABILEZ CONTROL BY THE CENTER.

 9. ALL EFFORTS MUST BE UNDERTAKEN TO PREVENT ANY EROSION OR TURBID WATER FROM BEIND DISCHARGED INTO WETLANDS AND/OR WATERS OF THE COUNTY. TURBID DISCHARGES THAT EXCED BO JUTYS (JACKSON NURBIDITY CONTROL OR THIS (NEPHELOMETRIC TURBIDITY UNITS) ABOVE BACKGROUND LEVELS SHALL NOT BE EXCEDED. HAY BALES, SILT FENCES OR OTHER BEY APPROVED METHODS OF EROSION/TURBIDITY CONTROL ARE EXQUIRED. CONTROLS SHOWN ARE MINMIUM REQUIREMENTS. INSTALLATION AND MAINTENANCE OF ADEQUATE CONTROLS SHALL BE THE RESPONSIBILITY OF THE GENERAL CONTROL SHALL BE THE RESPONSIBILITY OF THE GENERAL CONTROL SONTROLS SHALL BE MAINTAINED IN GOOD CONDITION THROUGHOUT THE CONSTRUCTION PROCESS AND UNTIL ALL LOOSE SOILS HAVE STABILIZED. CONTROL OF SMALL BE INSPECTED REGULARLY AND MODIFIED AS REQUIRED FOR PROPER OPERATION.

- EROSION CONTROL NOTES -

ALL EROSION CONTROL MEASURES (SILT BARRIERS) MUST BE INSTALLED PRIOR TO THE START OF CONSTRUCTION AND REMAIN IN PLACE THROUGHOUT CONSTRUCTION. ENCROACHMENT OR FAILURE TO MAINTAINTHESE BARRICADES COULD RESULT IN ENFORCEMENT ACTION WHICH MAY INCLUDE CITATIONS AND/OR PERMIT REVOCATION. SILTATION BARRIERS SHALL BE MAINTAINED AND REPAIRED AT THE END OF EACH WORKING DAY. HAY BALES SHALL BE INSTALLED ONCE PERMITER GRADING IS COMPLETED. STORMWATER FACILITIES SHALL HAVE HAY BALES PLACED AROUND THEIR ENTRANCES TO PREVENT SEDIMENT FROM BEING TRANSPORTED INTO THE STORMWATER FACILITIES SHALL HAVE HAY BALES SHALL BE PLACED ALONG THE PERMITER OF ALL DOWNSTREAM BOUNDARIES TO PROVIDE FILTRATION OF RUNOFF DURING CONSTRUCTION. THE HAY BALES SHALL BEMAIN IN PLACE UNITL THE ENGINEER HAS APPROVED THE VEGETATIVE COVER ALONG EMBAINKMENTS PROVIDING RUNOFF TO THE PERMITERE. IT IS THE CONTRACTOR'S RESPONSIBILITY TO MAINTAIN SOIL EROSION CONTROL DEVICES. IF AT ANY TIME DRAINAGE STRUCTURES OR EROSION CONTROL DEVICES BECOME DAMAGED OR INOPERABLE, IT IS THE CONTRACTOR'S RESPONSIBILITY TO REPAIR THEM. THE CONTRACTOR'S EXPECTED, AT THE END OF EACH DAY, TO HAVE THE SITE GRADED IN SUCH A WAY THAT ADJACENT PROPERTIES ARE NOT ADVERSELY MARACTED BY EROSION OR SEDIMENT LEAVING THE SITE. LEARNED AREAS SHALL BE STABILIZED EARLY IN THE CONSTRUCTION PROCESS AND IF NATURAL PRECIPITATION DOES NOT PROVIDE EARLY IN THE CONSTRUCTION PROCESS AND IF NATURAL PRECIPITATION DOES NOT PROVIDE PERSONO.

- CSWMP SIGNATURES-

NER: MAIN STREET LANDING, LLC P.O. BOX 2900 GAINSEVILLE, FLORIDA 32602-2900 PHONE: (352) 372-6172

OWNERS SIGNATURE AGENT

ENGINEER: SPRING ENGINEERING, INC. 3014 US HIGHWAY 19 HOUDAY, FLORIDA 34691 PHONE: (727) 938-1516

ROLAND P. DOVE, P.E. PROJECT ENGINEER #36933

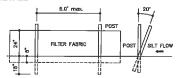
- LEGAL DESCRIPTION -

A PORTION OF LOTS 5-9 AND ALL OF LOTS 10-12, BLOCK 208, CITY OF NEW PORT RICHEY, AS SHOWN ON THE PLAT RECORDED IN PLAT BROCK 2, PAGE 27, OF THE PUBLIC RECORDS OF PASCO COUNTY, FLORIDA, BEING MORE PARTICULARLY DESCRIBED AS FOLLOWS:

ON THE PLAT RECORDED IN PLAT BOOK 2, PAGE 27, OF THE PUBLIC RECORDS OF PASCO COUNTY, FLORIDA, BEING MORE PARTICULARLY DESCRIBED AS FOLLOWS:

BEGIN AT THE SOUTHWEST CORNER OF LOT 12, BLOCK 208: THENCE ALONG THE EASTERLY RIGHT-OF-WAY LINE OF BURNER RODD, HORTH 23706 59" EAST, A DISTANCE OF 160.02 FEET, THENCE SOUTH 86°935" EAST, A DISTANCE OF 9.69 FEET, THENCE SOUTH 86°935" EAST, A DISTANCE OF 9.69 FEET, THENCE OF BEAT, A DISTANCE OF 20.70 FEET, THENCE SOUTH 85°940" AND STREEF COURSE. ASSET A DISTANCE OF 20.70 FEET, THENCE SOUTH 80°940" AND STREEF COURSE. SOUTH 80°940" AND THE BEGINNION MEANINE RUMP FOR MAN STREEF COURSE. SOUTH 80°940" AND THE BEGINNION MEANINE RUMP FOR MAN STREEF COURSE. A DISTANCE OF 20°940" AND THE BEGINNION MEANINE RUMP FOR MAN OF THE RESOUTH 37°43" WEST, A DISTANCE OF 17.26 FEET; THENCE SOUTH 80°940" AND STREEF COURSE. SOUTH 8

-SILT FENCE DETAIL



FILTER FABRIC TO CONFORM WITH F.D.O.T. SPECIFICATIONS (SEC. 983)
 POSTS TO BE 2"x4" WOOD POST OR 1.3 LB/FT STEEL POST.
 POST POSTON TO BE CAMETED (20") OR VERTICAL (90").
 DO NOT DEPLOY IN A MANNER THAT SILT FENCE WILL ACT AS A DAM ACROSS PETMANERT FLOWING WAITER COURSES.



Construction Surface Water Management Plan



CONTRACTOR SHALL

PITHLACHASCOTEE RIVER

-CONTRACTOR SHALL INSTALL TURBIDITY BARRIER PER DETAIL ON THIS SHEET

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100% CONSTRUCTION DOC'S ISSUE DATE: 02-23-16

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ROLAND P. DOVE, P.E.
P.E. No. 36933

IN STREET LANDIN
New Port Richey, Florida

CONTRACT DATE: July 20, 2004

SPRING ENGINEERING, INC.

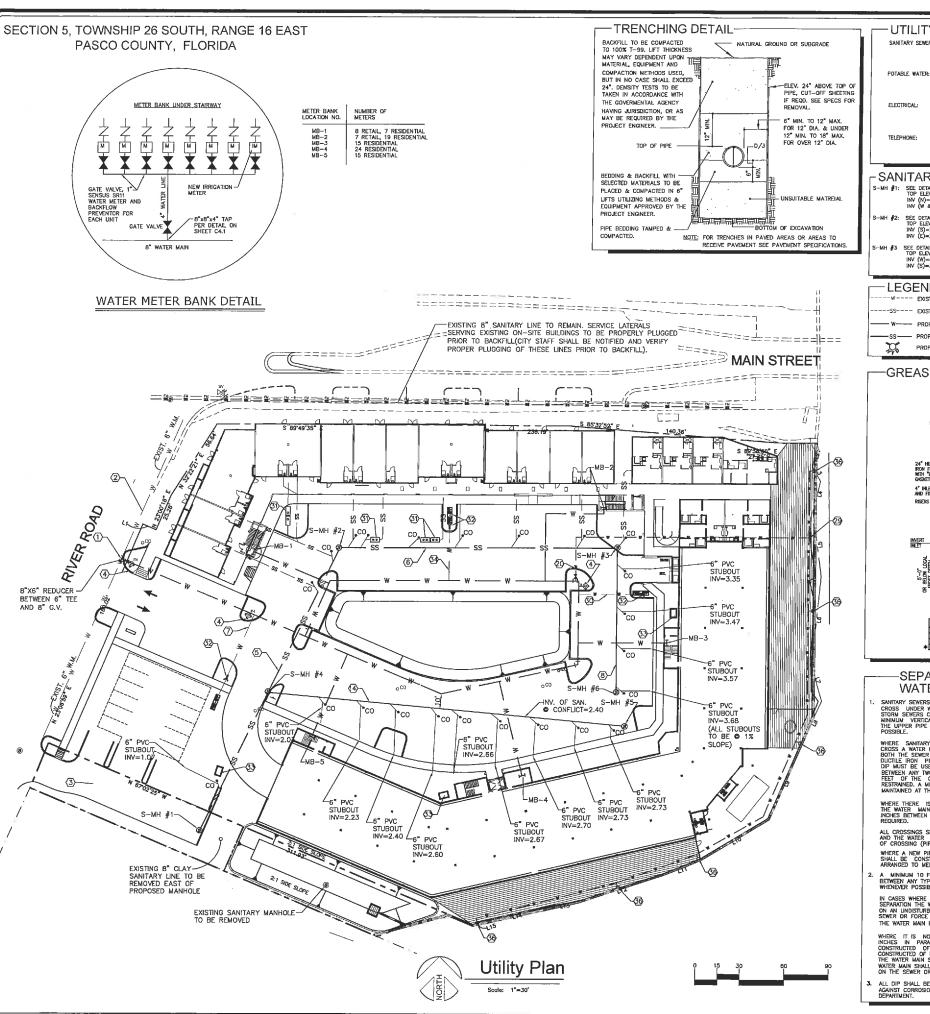
SIGNINEERING • LAND PLANNING • ARCHITECTURE
5014 U.S. HWY 19, HOLIDAY, FL (727) 938-1516
FL COA NO. ORODSISS & LIGENTE NO. AA-DOOTAY

CONSTRUCTION SURFACE WATER MANAGEMENT PLAN

DESIGNED BY: JPE
DRAWN BY: JPE
CHECKED BY: RPD

2004-26

C3.2



-UTILITY CONTACTS

CITY OF NEW PORT RICHEY PUBLIC WORKS 6420 PINEHILL ROAD PORT RICHEY, FL 34668 BARETT DOE (727) 841-4541 SANITARY SEWER:

CITY OF NEW PORT RICHEY PUBLIC WORKS 6420 PINEHILL ROAD PORT RICHEY, FL 34668 BARETT DOE (727) 841-4541

ROB CRANFORD (727) 599-4609

VERIZON 1280 E. CLEAVELAND AVENUE CLEARWATER, FLORIDA 33755

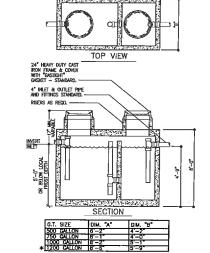
SANITARY MANHOLE INDEX

SEE DETAIL ON SHEET C4.1 TOP ELEV=7.55 INV (S)=2.15 INV (E)=2.25

LEGEND

EXISTING WATER LINE

-GREASE TRAP DETAIL



-SEPARATION FOR WATER/SEWER CONFLICTS

SANITARY SEWERS, FORCE MAINS AND STORM SEWERS SHOULD ALWAYS CROSS UNDER WATER MAINS. SANITARY SEWERS, FORCE MAINS AND STORM SEWERS CROSSING WATER MAINS SHALL BE LAD TO PROVIDE STORM SEWERS OF THE MAINS SERVED. THE MORE OF

WHERE A NEW PIPE CONFLICTS WITH AN EXISTING PIPE, THE NEW PIPE SHALL BE CONSTRUCTED OF DIP AND THE CROSSING SHALL BE ARRANGED TO MEET THE REQUIREMENTS ABOVE. A MINIMUM 10 FOOT HORIZONTAL SEPARATION SHALL BE MAINTAINED BETWEEN ANY TYPE OF SEWER & WATER MAIN IN PARALLEL INSTALLATION WHENEVER POSSIBLE.

IN CASES WHERE IT IS NOT POSSIBLE TO MAINTAIN 10 FOOT HORIZONTAL SEPARATION THE WATER MAIN MUST BE LAD IN A SEPARATE TRENCH OR ON AN UNDISTURBED EARTH SHELF LOCATED ON ONE SIDE OF THE SEWER OR FORCE MAIN AT SUCH AN ELEVATION THAT THE BOTTOM OF

WHERE IT IS NOT POSSIBLE TO MAINTAIN A VERTICAL DISTANCE OF 18 INCHES IN PARALLEL INSTALLATIONS THE WATER MAIN SHALL BE CONSTRUCTED OF DIP AND THE SEMER OR THE FORCE MAIN SHALL BE CONSTRUCTED OF BY WITH A MINIMUM VERTICAL DISTANCE OF 8 INCHES THE WATER MAIN SHOULD ALAWYS BE ABOVE THE SEMERA JOINTS ON THE WATER MAIN SHALL BE LOCATED AS FAR APART AS POSSIBLE FROM JOINT ON THE SEMERA OF ROPECEMEN (STAGGERED JOINTS).

ALL DIP SHALL BE CLASS 50 OR HIGHER. ADEQUATE PROTECTIVE MEASURING AGAINST CORROSION SHALL BE AS REQUIRED BY THE PERMITTING UTILITIES DEPARTMENT.

-UTILITY KEY NOTES

- CONTRACTOR TO INSTALL NEW ±598 LF OF 8" SCH. 40 DR18 WATER LINE FROM EXISTING 6" WATER MAIN, SEE TAPPING DETAIL ON SHEET C4.1.
- $\langle 2 \rangle$ EXISTING 6" CI WATER LINE.
- (3) EXISTING 8" GRAVITY SANITARY SEWER LINE.
- (4) CONTRACTOR TO INSTALL NEW FIRE HYDRANT ASSEMBLY PER DETAIL ON SHEET C4.1.
- (5) CONTRACTOR TO INSTALL ±208 LF, 8" PVC SANITARY SEWER LINE (© 0.49% SLOPE) FROM SM-#1 TO SM-#2.
- 6 CONTRACTOR TO INSTALL ±184 L.F. 8" PVC SANITARY SEWER LINE (© 0.4% SLOPE) FROM SM-#2 TO SM-#3.
- (7) CONTRACTOR TO INSTALL ±45 LF. 2 1/2" CPVC FIRE LINE
- (8) CONTRACTOR TO INSTALL ±94 L.F. 8" PVC SANITARY SEWER LINE (© 0.4% SLOPE) FROM SM-#3 TO SM-#6.

- 27 CONTRACTOR TO INSTALL ±55L.F. 3" W.M. SCH, 40 DR18
- (28) WATER SERVICE TO DWELLING UNITS SHALL BE INDIVIDUALLY METERED WITH DOUBLE CHECK VALVE BACKFLOW DEVICES INSTALLED IN A VALVE BOX BETWEEN THE METER AND THE DWELLING UNIT. SEE DETAIL ON SHEET C4.1.
- (29) CONTRACTOR TO INSTALL TEMPORARY BLOW OFF VALVE FOR BOAT DOCKS SEE DETAIL ON SHEET C4.1.
- (31) 1200 GALLON GREASE TRAP PER DETAIL THIS SHEET.
- (32) FIRE UNE BACKFLOW PREVENTER WITH FIRE DEPARTMENT CONNECTION
- (34) CONTRACTOR TO INSTALL ±38 L.F. 6" C-900 DR14 PVC FIRE LINE
- (36) CONTRACTOR TO CONNECT HOSE CABINET TO 3" PVC WATER LINE

- UTILITY NOTES

MANHOLES SHALL BE INSPECTED BY THE CITY BEFORE PLACEMENT AND SURFACE TREATMENT.

ALL OPENINGS IN PRECAST MANHOLES SHALL BE CAST AT TIME OF MANUFACTURE, CONNECTIONS TO EXISTING MANHOLES SHALL BE CORE ENTRY ONLY. ALL MANHOLES SHALL BE SET PLUMB TO LINE AND GRADE.

(PVC) GRAVITY SEWER PIPE SHALL CONFORM TO ASTM D-3034, SOR 35, LATEST REVISIONS, WITH PUSH ON RUBBER GASKET JOINTS.

(DIP) GRAVITY SEWER PIPE SHALL BE CLASS 52, EPOXY LINED OR AS OTHERWISE APPROVED BY CITY ENGINEER.

MANHOLE FRAMES SHALL BE ATTACHED TO THE PRECAST STRUCTURE WITH A MINIMUM OF TWO 3/4" 316 STAINLESS STEEL BOLTS, NUTS AND WASHERS, FRAMES SHALL BE SEALED WITH A MINIMUM OF TWO 1/2" BEADS OF RAM-NEK CAULKING.

TRENCHES SHALL BE DE-WATERED TO ENABLE PIPE AND APPURTENANCES TO BE INSTALLED FREE OF WATER ON UNDSTUBBED SOIL IF UNSUITABLE SUBSURFACE MATERIAL IS ENCOUNTERED, EXCAVATE EXTRA 6° AND BACKFILL WITH 3/4° CRAVEL

BACKFILL MATERIAL FOR SEWER MAIN AND LINES SHALL BE NON-COHESIVE, NON PLASTIC MATERIAL FREE OF ALL DEBRIS, LUMPS AND ORGANIC MATTER. BACKFILL MATERIAL PLACED MITHIN ONE (1) FOOT OF PIPING AND APPLIETABACES SHALL NOT CONTAIN ANY STONES LARGER THAN TWO (2) RICHES IN DIAMETER (1° FOR PVC PIPE) AND NO STONE LARGER THAN SIX (6) INCHES IN DIAMETER WILL BE PERMITTED IN ANY BACKFILL.

UPON COMPLETION OF THE WORK AND PROR TO PLACEMENT OF ASPHALT A VISUAL INSPECTION AND VIDEO RECORDING SHALL BE MADE OF THE COMPLETED SYSTEM. THE CITY SHALL APPROVE THE SYSTEM PRIOR TO IT BEING PLACED IN SERVICE AND BEING ACCEPTED FOR MAINTENANCE.

COMPLETE "AS BUILT" INFORMATION RELATIVE TO MANHOLES, VALVES, SERVICES, FITTINGS, PIPE LENGTHS, INVERTS AND SLOPES SHALL BE ACCURATELY RECORDED AND SUBMITTED TO THE CITY SIGNED AND SEALED BY A REGISTERED LAND SURVEYOR.

DRAWINGS WILL CONFORM TO ALL LOCAL FIRE DEPARTMENT AND NEPA REQUIREMENTS

ALL SANITARY SEWERS SHALL BE TESTED USING A MANDREL

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CONSTRUCTION DOC'S SUE DATE: 02-23-16

ANDING STREETL New Port Richey, MAIN

July 20, 2004

S ENGINEERING,

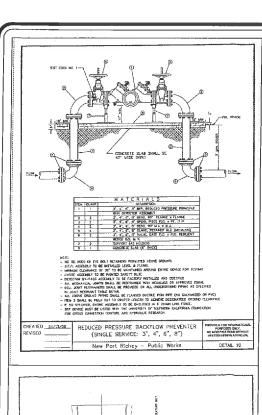
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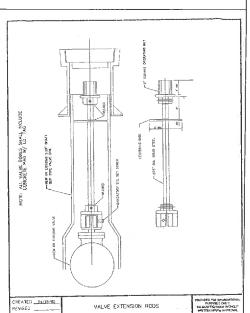


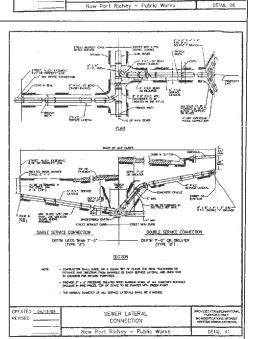
DRAWN BY: JPE CHECKED BY: RPD

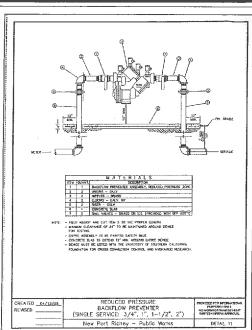
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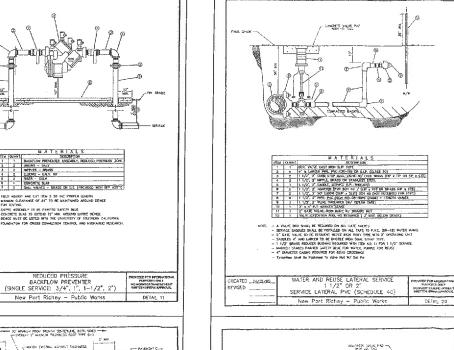


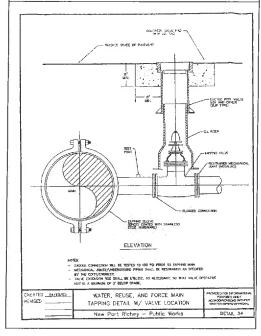


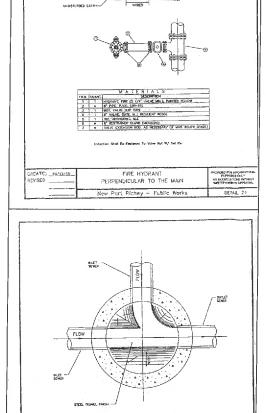
UNITS OF BASE REPLACEMENT -

PRE BEDOED TO CENTERUNE
N COMPACTED SAND
4" MINORIA UNDER PPE.

PHONESE FOR INFORMATION PURPOSES CHALY, NO MODIFICATIONS SAT 10031 WHITTEN MESSAY AN PROVAL



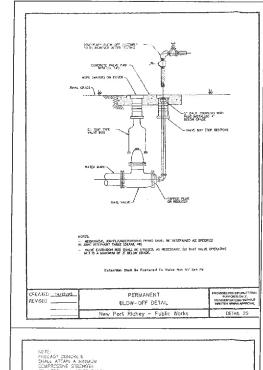


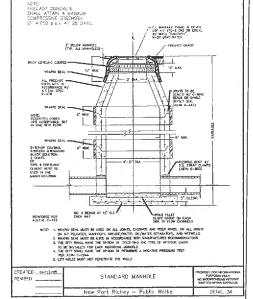


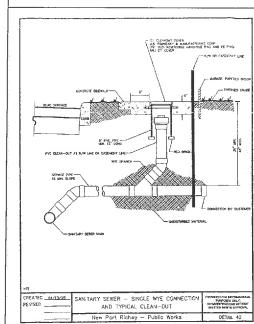
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- CONCRETE VALVE PAG MIN LO YAG

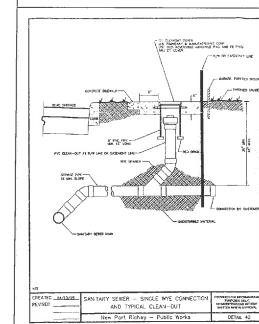
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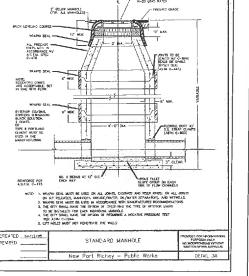


PIPE LAYING CONDITIONS FLOWABLE FILL BACKFUL EXISTING PAVED AREAS & ROADWA



DR SELECT MATCHAN TO 6" ABOVE TOP OF PA

CREATED 04/13/35 REVISED



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100% CONSTRUCTION DOC'S ISSUE DATE: 02-23-16

ROLAND P.E. N

STREET LANDING

Port Richey, Florida

MAIN

CONTRACT DATE: July 20, 2004

ENGINEERING,

SPRING

INC.
HITECTURE
938-1516

• ARCHIT (727) 93

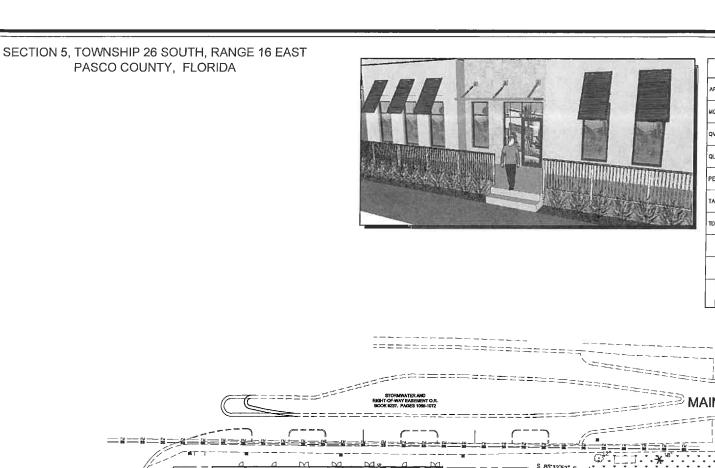
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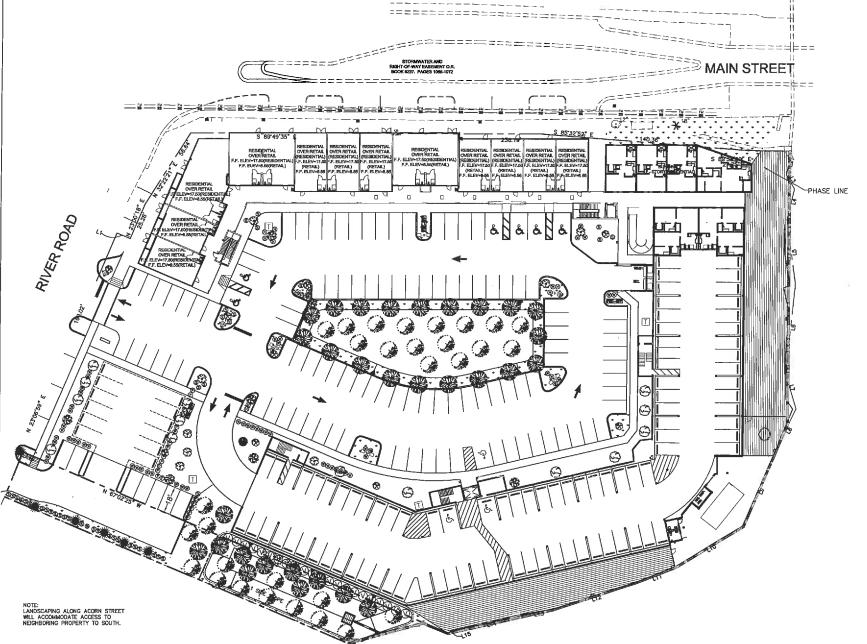
New Port Richey,

DESIGNED BY: JPE
DRAWN BY: JPE
CHECKED BY: RPD
JOB NUMBER
2004-26

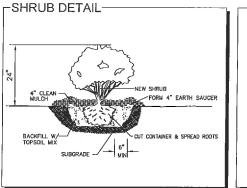
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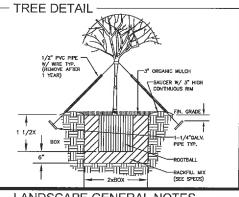


Г	PLANTING LEGEND Notive Drought															
	SHA	ADE TREES Symbol	No.	Scientific Name	Common Name	Size Requirements	Native Florida	Drought Tolerant	L	Shrub Symbol	No	Scientific Name	Common Name	Size Requirements	Florido	Tolerant
ı	Т		ГП			8' height (min.)			1		0	CAMELLIA JAPONICA 'PROF. SERGEANT'	PROF. SERGEANT CAMALEA	24" height; 3 gal; 24" O.C.	NO	NO
	AR		11	ACER RUBRUM	RED MAPLE	3" callper (min.)	YES	ND		W	77	VIBURNUM OBOVATUM	WALTER VIBURNUM	24" height; 3 gal.; 24" O.C.	YEŞ	YES
M	IG	5 45 S	8	MAGNOLIA GRANDIFLORA	SOUTHERN MAGNOLIA	8' height (mln.) 3" caliper (min.)	YES	YES		<u> </u>	46	SPIRAEA CANTONIENSIS	REEVE'S SPIRAEA	24" height; 3 gal.; 24" O.C.	NO	YES
H	+	Jakar .								\oplus	16	ILEX VOMITORIA 'SCHELLINGS DWARF'	SCHELLINGS DWARF YAUPON HOLLY	24" height; 3 gal.; 24" OC	YES	YES
٩	ıν	新	9	QUERCUS VIRGINIANA	LIVE OAK	6' height (min.) 3" collper (min.)	YES	YES		6	٥	ILEX CORNUTA BURFORDII NANA	DWARF BURFORD HOLLY	24" height; 3 gal.; 24" OC	NO	YES
l.	_	5° P				B' height (min.)				®	41	FORESTIERA SEGREGATA	FLORIDA PRIVET	30" height; 5 gal.; 48" OC	YES	YES
q	1-1	Con	14	QUERCUS LAURIFOLIA	LAUREL OAK	3" caliper (mln.)	YES	YES		0	40	VIBURNUM ODORATISSIMUM	SWEET VIBURNUM	30" height; 5 gal.; 48" OC	NO	YES
P	E		6	PINUS ELLIOTTII	SLASH PINE	8' height (min.) 3" caliper (min.)	YES	YES	۷Od		0	VIBURNUM SUSPENSUM	SANDANKWA VIBURNUM	30" height; 5 gal.; 48" OC	NO	YES
-	\perp	777	$\vdash \vdash$			5 Edilper (min.)				GROUNDCOVER Symbol		Scientific Name	Common Name	Size Requirements	Native Florida	Drought Tolerant
T.	Α		30	TAXODIUM ASCENDENS	POND CYPRESS	8' height (min.) 3" caliper (min.)	YES	YES		₿		BUXUS MICROPHYLLA	BOXWOOD	3 gal.; 36° O.C.	МО	YES
H	+					8' height (min.)						HELIANTHUS DEBILIS	BEACH SUNFLOWER	4" or 1 qt; 18" O.C.	YES	YES
, m	P		30	TAXODIUM DISTICHUM	BALD CYPRESS	3" coliper (min.)	YES	YES				CRINUM AMERICANUM	STRING LILY	1 gal.; 36" O.C.	YES	NO
Г	Τ		П									LANTANA INVOLUCRATA or DEPRESSA	WILD SAGE or PINELAND LANTANA	1 gal.; 36" O.C.	YES	YES
L	╀											RUDBECKIA HIRTA	BLACK-EYED SUSAN	1 gal.; 36" O.C.	YES	YES
												IBERIS SPP.	CANDYTUFT	4" or 1 qt; 12" O.C.	NO	NO
-	+		\forall									PASPALUM NOTATUM	BAHIA SOD	1 gal.; 24" O.C.	YES	YES
												PASPALUM NOTATUM	BAHIA SEED		YES	YES
\perp																



Landscape Plan





-LANDSCAPE GENERAL NOTES

LI. LANDSCAPE GENERAL NOTES

LI. LANDSCAPING: ALL PLANT MATERIALS USED SHALL CONFORM
TO THE STANDARDS FOR FLORIDA NO. 1 OR BETTER AS GIVEN IN
ORADES AND STANDARDS FOR NURSERY PLANTS, PART I, 1985 AND
PART II, STANDARDS FOR NURSERY PLANTS, PART I, 1985 AND
PART II, STANDARDS FOR NURSERY PLANTS, PART I, 1985 AND
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PART II, STANDARDS FOR PLANTS, INSTALLER SHALL NOT TREES AD
PART II, STANDARDS FOR NURSERY PLANTS INSTALLER SHALL INSPECT SITE
PRIOR TO BEGINNING PLANTING OPERATIONS AND NOTIFY ARCHITECT
OF ANY DISCREPANCES, INSTALLER SHALL INMEDIATELY NOTIFY
ARCHITECT IF ANY CONFLICTS OCCUR BETWEEN PROPOSED LOCATION OF
TREES CALLED FOR ON THE PLANS AND ANY UNDERSOUND UTILITIES
OR SUBSURFACE STRUCTURES. INSTALLER SHALL NOTIFY ARCHITECT OF
ANY CONDITION THAT WOULD PREVENT THE HEALTHY OROWTH OF
PLANT SPECIES CALLED FOR ON THESE CALLES ARE OF THE
ANAMA ALL AURISCAPE, AREAS SHO FRALES PROPOSED ICONTRACT
AWARD ALL AURISCAPE, AREAS SHO FRALES PROPOSED IS
TO BE PROPERLY PREPARED AND FERTILIZED PRIOR TO LAYING SOO.
THERE SHALL BE A CRISP LINE SEPARABING PLANT BEDS FROM ALL
SOO AREAS, SOO TO BE STAVED AS RECESSARY TO PREVENT
EROSION. CONTRACTOR TO SOO ALL DISTURBED AREAS DUE TO PROPOSED
CONSTRUCTION.

-EXISTING TREE LEGEND



-TREE SUMMARY

TREES APPROVED FOR REMOVAL IN 2005 W/O REPLACEMENT. A. CEDARS — 268 INCHES B. OAKS — 972 INCHES

PROPOSED NEW TREES
A. RED MAPLE - 33 INCHES
B. SOUTHERN MAGNOUA - 24 INCHES
C. LIVE OAK - 27 INCHES
D. LAUREL OAK - 42 INCHES
E. SLASH PINE - 18 INCHES
E. SLASH PINE - 18 INCHES
G. BALD CYPRESS - 90 INCHES
G. BALD CYPRESS - 90 INCHES
TOTAL REPLACED = 324 RICHES

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ONSTRUCTION DOC'S.

SSUE DATE: 02-23-16

STREET LANDING New Port Richey, Florida MAIN

CONTRACT DATE: July 20, 2004

S ENGINEERING, INC.

• LAND PLANNING • ARCHITECTURE

PY 19, HOLIDAY, FL (727) 938–1516

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LAND PLANNING •
19, HOLIDAY, FL (
opogs158 & LICENCE NO.) **SPRING**

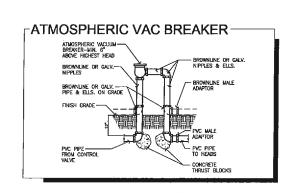


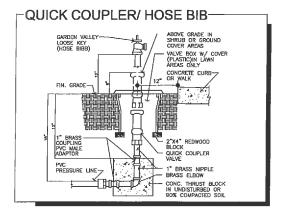
LANDSCAPE PLAN

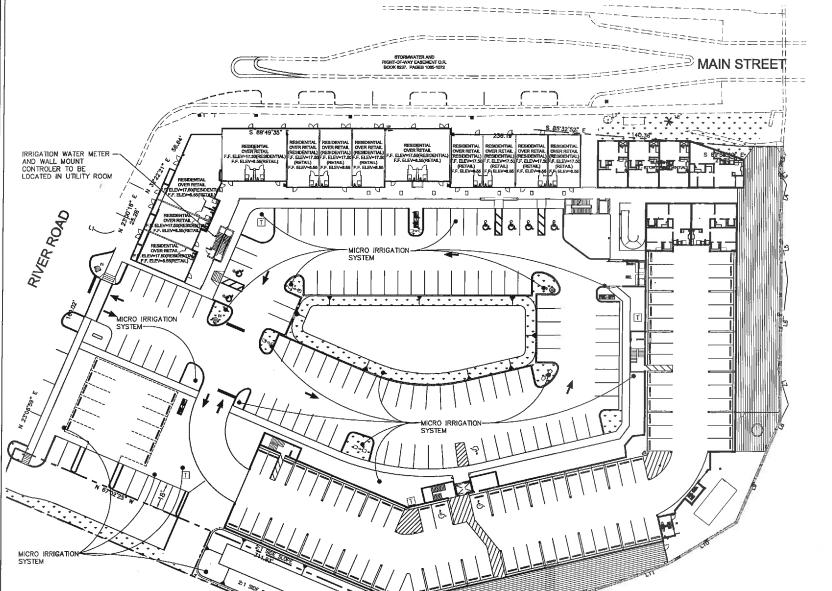
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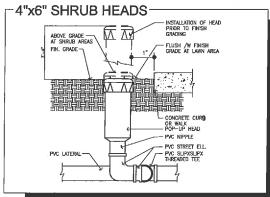
SECTION 5. TOWNSHIP 26 SOUTH, RANGE 16 EAST PASCO COUNTY, FLORIDA



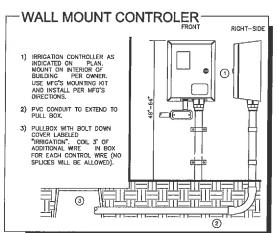


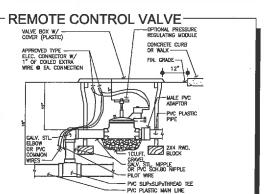


Irrigation Plan



TRENCH DETAIL (1) BACKFILL TO BE WATERED DOWN, NATIVE ROCK FREE SOIL, COMPACTED TO 90% DENSITY AND GRADED FLUSH. CONTINUOUS DETECTABLE WARNING TAPE TO BE BURIED 6" OVER PVC LINES AND CONTROL WIRES. 3) PVC (SCH 40) LATERAL LINE TO BE A MINIMUM OF 12" DEEP. DRIP LATERAL TO BE A MINIMUM OF 6" DEEP, CONTROL MINING TO BE BURIED UNDER MAIN LINE AND TAPED WITH PVC TAPE TO MAIN AT 10" INTERVALS. MAIN LINE TO BE A MINIMUM OF 18" DEEP. ALL WRE RUNS LESS TIME, SOO" OO LESS THAN 500' SHALL HAVE NO



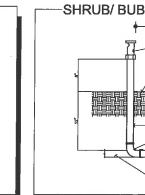




- 4. Contractor shall verify available flow and pressure downstream from the point—of-connection prior to system installation. Contractor shall notify Architect immediately if available flow is less than required to run the largest zone. Contractor shall not proceed any further with installation of the system until necessary revisions have been determined by the Architect.
- 5. The Contractor shall not willfully install the sprinkler system as shown on the draw when it is obvious in the field that unknown obstructions or differences in dimensions exist that milght have been unknown during engineering. Such obstructions shall be brought to the attention of the Owner's authorized representative. In the event this revisions necessary of the coat to the Owner of the Owner or the Owner of the Owner or the Owner of the Owner or the Owner of t

- 9. All valves are to be located in planting areas wherever possible and in lockable valve

- 15. Install all pipe and control wire, which runs under paying, within Sch. 40 PVC sleet 2th dia. minimum size as required to allow installation without binding. Provide (1) sleeper pipe. Provide separate sleeves for control wire.
- 16. Schedule 40 PVC is required for all pressure lines and under all paved creas. Piping must be installed a min. of 12⁸ underground for non pressure Irrigation lines and 18⁸ underground for constant pressure Irrigation lines.
- 17. All irrigation materials and installation shall comply with the Uniform Plumbing Code.
- 18. Plping shall be completely flushed of foreign particles before attaching irrigation components and drain valves.
- 20. After flushing, lateral pipes shall be tested with risers capped and drain valves also. The test shall be made at maximum operating pressure for a period of not less than hour. All joints showing leaks shall be cleaned, remade, and tested. All testing shall be done in the presence of the Owner's representative prior to backfilling over piping.
- SUBMITTALS
- 23. Contractor shall prepare and Issue to the Owner (at completion of the Installation) on annual chart Indicating location, operating dates, cycles, and time for each zone.
- Contractor shall unconditionally guarantee the Irrigation system for a period of one year from the date of Final Acceptance. Manufacturer warranties shall only exceed this guarantee and Contractor shall be liable for repairs/replacement of falled material/warkmanship.

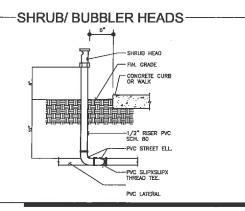


IRRIGATION NOTES

Plan is diagrammatic only. Finci location of lines and heads shall be determined in the field and approved by the Architect. Lines shall be in a common trench wherever oscible. The point of connection shall be as indicated on the plans.

- FLUSHING AND TESTING

- 21. Operational Testing: Perform operational testing after hydrostatic testing is complemonstrate to the Architect that the system mosts coverage requirements (100%) of that automatic controls function properly.



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CONSTRUCTION DOC'S SSUE DATE: 02-23-16

> ANDING Florida STREETL New Port Richey, MAIN

July 20, 2004

:HITECTURE 938–1516 1747 ENGINEERING, INC. LAN 19, JEERING . U.S. HWY FL COA NO. SPRING

IRRIGATION

DESIGNED BY: JPE
DRAWN BY: JPE
CHECKED BY: RPD

2004-26 C6.0

GENERAL NOTES —

- THE LOCATIONS, ELEVATIONS AND DIMENSIONS OF EXISTING UTILITIES, STRUCTURES AND OTHER FEATURES ARE SHOWN ACCORDING TO THE BEST INFORMATION AVAILABLE AT THE TIME OF THE FREPARATION OF THESE PLANS BUT DO NOT PURPORT TO BE ASSOLUTELY CORRECT. THE CONTRACTOR SHALL FIELD VERIFY THE LOCATIONS, ELEVATIONS AND DIMENSIONS OF ALL EXISTING UTILITIES, STRUCTURES AND OTHER FEATURES AFFECTION HIS WORK PRIOR TO BIDDING AND DETERMINE THE EXACT LOCATION OF THE UTILITIES PRIOR TO CONSTRUCTION. THE CONTRACTOR SHALL HOLD SURSHING OF GOOD-YEAR OF TO NOT THE UTILITY COMPARES IN THE PRIVATE AND PUBLIC PROPERTY AFFECTED BY THIS WORK SHALL BE RESTORED TO AND THE UTILITY COMPARES IN ADMINISTRATION OF THE PRIVATE AND PUBLIC PROPERTY AFFECTED BY THIS WORK SHALL BE RESTORED TO A COUNTING FOLIAL TO OR BETTER THAN EXISTED BEFORE COMMENCING CONSTRUCTION UNLESS SPECIFICALLY EXEMPTED BY THE PLANS. COST TO BE INCIDENTAL TO OTHER CONSTRUCTION ON EXTRA COMPENSATION TO BE ALLOWED.
- ALL WORK SHALL BE LEFT IN SUCH A MANNER THAT IT IS SAFE TO THE PUBLIC. THE CONTRACTOR SHALL MAINTAIN TRAFFIC AT ALL TIMES. SIGNARD BARRICADES TO BE ACCORDING TO FLO.C. NAWIVLA OF SAFE PRACTICES; REFERENCE F.D.O.T. INDEXES 600 THROUGH 650 AND 17349 FER ROADWAY AND TRAFFIC DESIGN STANDARDS LATEST EDITION OF D.C. INDEXES 100 THROUGH 116. THERE WILL BE NO ON—SITE BURNING.
- ADDITIONAL CONTROL AND SCOPE OF WORK: THE CONTRACTOR SHALL PROVIDE SPRING ENGINEERING, INC. WITH AS-BUILT DRAWINGS AND SURVEYS UPON COMPLETION OF ALL WORK.
- SURVEYOR SHALL DO ALL BUILDING LAYOUT, CURB & ROADWAY, AND GRADE STANING. THE CONTRACTOR SHALL VERBY ALL DIMENSIONS IN THE FIELD AND REPORT ANY DISCREPANCES TO THE ENGINEER PRIOR TO STARTING ANY WORK. THE CONTRACTOR SHALL CONTACT THE ENGINEER'S OFFICE LIMPEDIATELY ON ANY CONFLICTS ASSIND DURING CONSTRUCTION OF ANY IMPROVEMENTS SHOWN ON THESE DRAWNIGS. IT SHALL BE THE CONTRACTOR'S RESPONSIBILITY TO CONSULT WITH THE ENGINEER FOR MAKING ANY AND ALL REQUIRED INTERPRETATIONS OF THE PLANS; HOWEVER, THIS IN NO MAY RELIVES THE CONTRACTOR OF HIS RESPONSIBILITY FOR CONSTRUCTIONS THE PROJECT TO ACCOMPLISH THE INTENT OF THE PLANS; ALL ELEVATIONS RESPONSIBILITY FOR CONSTRUCTIONS THE PROJECT TO ACCOMPLISH THE INTENT OF THE PLANS, ALL ELEVATIONS REFER TO NATIONAL GEODETIC VERTICAL DATUM OF 1929, MEAN SEA LEVEL = 0.00.
- PERMITS: NO CONSTRUCTION SHALL COMMENCE UNTIL ALL APPLICABLE PERMITS HAVE BEEN APPROVED. A RIGHT-OF-WAY USE PERMIT IS REQUIRED PRIOR TO THE COMMENCEMENT OF ANY CONSTRUCTION ACTIVITY WHININ THE RIGHT-OF-WAY, AND NO IRRIGATION SYSTEM OR LANDSCAPING SHALL BE INSTALLED IN ANY PUBLIC RIGHT-OF-WAY WHITOUT ISSUANCE OF APPROPRIATE PERMIT, ALL PROPOSED SIONS MUST BE APPLIED FOR APPLICATION OF A PROPOSED SITE PLAN APPROVAL OF THIS SITE PLAN DOES NOT CONSTITUTE APPROVAL OF ANY SOAL
- STRIPING: HANDICAPPED PARKING SPACES MILL BE PROPERLY SIGNED AND M. STRIPED IN ACCORDANCE WITH FLORIDA STATUTE 316, THE MANUAL ON UNIFORM TRAFFIC CONTROL DEVOCES, OR OTHER APPLICABLE STANDARDS. ALL ON-SITE PARKING SPACES SHALL BE STRIPED AND SIGNED IN ACCORDANCE WITH THE MANUAL ON UNFORM TRAFFIC CONTROL DEVICES, LATEST EDITION, PARKING SPACES, DIRECTIONAL ARROWS, AND STOP BARS SHALL BE STRIPED IN WHILE, IT SHALL BE THE OWNER/DEVLOCATE RESPONSIBILITY TO PROPERLY SIGN AND STRIPE THE SITE IN ACCORDANCE N. WITH APPLICABLE STANDARDS.
- CONCRETE: CONCRETE SHALL HAVE A COMPRESSIVE STRENGTH OF 3,000 O. PSI AT 28 DAYS. PORTLAND CEMENT SHALL CONFORM TO ASTM C150. ACGRECATE SHALL CONFORM TO ASTM C150. ACGRECATE SHALL CONFORM TO ASTM A185. READY MIXED CONCRETE SHALL CONFORM TO ASTM C194. SIX INCH MESS, 10 CAUGE WIRE FABRIC SHALL BE USED IN SLABS THICKER THAN FOUR INCHES, STANDARD THICKNESS SHALL BE GIVEN INCHES, EXCEPT AT DRIVEWAYS WHERE THE THICKNESS SHALL BE SIX INCHES, SUFFACES SHALL BE SIX INCHES, SUFFACES SHALL BE FREE FROM RICHEL OWNER A TOOM STANDARD SHALL BE SIX INCHES. SUFFACES SHALL BE SIX INCHES.
- A BROOM FINISH.

 JUNIDES, ALL UNDERGROUND UTILITIES MUST BE INSTALLED BEFORE BASE AND SLIFFACE COURSES ARE CONSTRUCTED. SITE CONTRACTOR IS RESPONSIBLE FOR INSTALLING ALL UTILITIES IN ACCORDANCE WITH LOCAL CODES, WHETHER INDICATED ON THE PLANS OR NOT. CHECK WITH THE LOCAL COVERNMENT PRIOR TO BIG DUBMISSION. THE CONTRACTOR SHALL TAKE ALL NECESSARY MEASURES TO MINIMIZE INTERRUPTIONS OF ENSINING UTILITY SERVICE DURING CONSTRUCTION AND CONNECTION OF PROPOSED SERVICE INNES. CONFLICTS BETWEEN MATER LINES AND STORM/SANITARY OF SERVICESSARY. CONTRACTOR SHALL SH
- J. SANITARY SEWERS: ALL SANITARY SEWER MAINS TO BE SDR-26 PVC. $^{\mathrm{Q}_{\mathrm{c}}}$
- THEE BARRICADES AND EROSION CONTROL. ALL EROSION CONTROL MEASURES (SILT BARRICRS) AND TREE BARRICADES MUST BE INSTALLED FROM TO FEMALE TO MAINTAIN THESE BARRICADES COLUMN TO FAILURE TO MAINTAIN HESE BARRICADES COLUMN ENGROACHMENT OF FAILURE TO MAINTAIN HESE BARRICADES COLUMN SENTALLED AND THESE BARRICADES COLUMN SELTATION BARRIERS AND THE STORMAND AND THE STORMAND THE PREPARE HE PROCESSED AND SENTAL BE DESCRIBED TO MAINTAIN BECKETT HAT DE PREPARE HE PROCESSED TO THE STORMAND THE ST

RUNOFF DURING CONSTRUCTION. THE HAY BALES SHALL REMAIN IN PLACE UNTIL THE ENGINEER HAS APPROVED THE VEGETATIVE COVER ALONG EMBANKWENTS REPOMIDING RUNOFF TO THE PERIMETER. IT IS THE CONTRACTOR'S RESPONSIBILITY TO MAINTAIN SOIL ERDISION CONTROL DEVICES. IF AT ANY TIME DRAINAGE STRUCTURES OR EROSION CONTROL DEVICES EGEOUNE DAMAGED OR INOPERABLE, IT IS THE CONTRACTORS RESPONSIBILITY OR REPAIR THEM. THE CONTRACTOR IS DEVELOPED. AT THE CONTRACTOR STRUCTURES OR EROSION CONTROL ADJACENT PROPERTIES ARE NOT ADVERSELY IMPACTORED BY EROSION OR SCOMENT LEAVING THE SITE. CLEARED AREAS SHALL BE STABILIZED EARLY IN THE CONTRACTOR SHALL PROVIDE PROVIDE METHOD OF THE SITE, THEM THE CONTRACTOR SHALL PROVIDE METHOD OF STAINT AREA SHOWN TO BE CLEARED ON THE PLAN. ORCE SHALL BE TAKEN TO DISTORE THE ENSITIES VECTATION OF SHALL BE TAKEN TO DISTORE THE ENSITIES VECTATION OF SHALL BE TAKEN TO DISTORE THE ENSITIES VECTATION OF SHALL BE TAKEN TO DISTORE THE ENSITIES VECTATION OF SHALL BE TAKEN TO DISTORE THE ENSITIES VECTATION OF SHALL BE TAKEN TO THE PLAN. ORCE SHALL BE TAKEN TO DISTORE THE ENSITIES VECTATION OF SHALL BE ENSITED VECTATION OF SHALL BE ENSITED OF SHALL BE ENSITED VECTATION OF SHALL BE AREAS SHALL BE EXPENDED VECTATION OF SHALL BE AREAS SHALL BE EXPENDED VECTATION OF SHALL BE ENSITED VECTATION OF SHALL BE PROVIDED BY THE LOCAL GOVERNMENT. ALL TREE FLOWS SILL BE ENSITED VECTATION OF ANY KIND WITHIN THE DRIPLINE OF A TIME OF THE EQUIPMENT OF ANY KIND WITHIN THE DRIPLINE OF A TIME OF THE PROVIDED OF THE LOCAL GOVERNMENT. ALL TREE FLOWS SILL BE PROVIDED BY THE LOCAL GOVERNMENT. ALL TREE PROVIDED OF THE LOCAL GOVERNMENT. ALL TREE PROVIDED OF ANY SIGNAL BE PROVIDED BY THE LOCAL GOVERNMENT. ALL TREE PROVIDE

- DRAINAGE: ALL DRAINAGE STRUCTURES MUST BE CONSTRUCTED PER FLORIDA DEPARTMENT OF TRANSPORTATION ROAD DESION STANDARDS. MITERGE DEND SECTION AS PER D.O.T. INDEX NO. 272 AND NO. 273. ALL PIPE LENGTHS ARE PLUS OR MINUS AND MEASUREMENTS ARE TO THE CENTER OF STRUCTURES. OWNER SHALL MAINTAIN RETENTION AREAS.
- DRIVES: ALL DRIVES SHALL BE IN ACCORDANCE WITH FDOT REQUIREMENTS.
- REQUIREMENTS.

 PAYING: ALL PAYING SURFACES IN INTERSECTIONS AND ADJACENT SCITIONS SHALL BE CRADED TO DRAIN POSITIVELY IN THE DIRECTION SHOWN BY THE FLOW ARROWS ON THE PLANS AND TO PROVIDE A SMOOTH TRANSITION WITH NO BREAKS IN ORADE AND NO STEEP OR REVERSE CROSS SHOWN AND ADDITION OF THE PLANS AND TO PROVIDE A SMOOTH TRANSITION WITH DRAIN SHOWN AND ADVISIBLE TO MAKE MINOR SHOWN AND ADJACENT TO ADJACENT TO THE PLANS AND PURPOSES OUTLINED. IT IS THE CONTRACTORS RESPONSIBILITY TO ENSURE POSITIVE DRAINAGE AND SET SHALL BE CONSULTED SO THAT WE MAY MAKE ANY AND ALL REQUIRED INTERPRETATIONS OF THE PLANS OR GIVE SUPPLEMENTARY INSTRUCTIONS TO ACCOUNTLISH THE INTENT OF THE PLANS. ASSPHALT CONCRETE TYPE STANDARD SPECIFICATIONS FOR FOMO AND BRIDGE CONSTITUTION LATEST TO ACCOUNTLISH THE INTENT OF THE PLANS. ASSPHALT CONCRETE TYPE STANDARD SPECIFICATIONS FOR FOMO AND BRIDGE CONSTITUTION LATEST TO ACCOUNT AND ADDITION OF THE PLANS ASSPHALT CONCRETE TYPE SENTING AND METHOD OF CONSTRUCTION. ALL ROADWAY BASES SHALL BE PRIMED AND, IF REQUIRED, A TACK COAT SHALL BE APPLIED. ALL MATERIALS AND CONTROL OF CONSTRUCTION, ALL ROADWAY BASES SHALL BE PRIMED AND, IF REQUIRED, A TACK COAT SHALL BE APPLIED. ALL MATERIALS AND CONTROLLED ON THE PLONGE CONSTRUCTION, ALL ROADWAY BASES SHALL BE PRIMED AND, IF REQUIRED A TACK COAT SHALL BE SECURED AND AND BRIDGE CONSTRUCTION, ALTERSTEED THE ADDITION OF THE PLONGE CONSTRUCTION, ALL ROADWAY BASES SHALL BE PRIMED AND AND BRIDGE CONSTRUCTION, ALTERSTEED THON. THE PLANS ASSPHALL BASE SHALL BASE SHALL BASE SHALL AND CONTROL PROVINCE THE ADDITION OF THE PLANS ASSPHALL AND DEPARTMENT OF TRANSPORTATION STRUCTURE.

AND APPROVAL SEE SPECIFICATIONS FOR SPECIFIC TESTING REQUIREMENTS.

LANDSCAPING: ALL PLANT MATERIALS USED SHALL CONFORM TO THE
STANDARDS FOR FLORIDA NO. 1 OR BETTER AS GIVEN IN GRADES AND
STANDARDS FOR NURSERY PLANTS, PART I, 19ES AND PART II, STATE OF
FLORIDA DEPT. OF AGRICULTURE, TALLAHASSEE, ALL PLANT MATERIAL WILL
BE GUARANIED FOR ONE (1) THE FROM DATE OF THAL ACCEPTANCE BY
MISTALLER SHALL INSPECT SITE PRIOR TO BEGINNIE PLANTING
OPERATIONS AND NOTIFY ARCHITECT OF ANY DISCREPANCIES. INSTALLER
SHALL IMMEDIATELY NOTIFY AGRITICET IF ANY COMPLICITS DOCUME BETWEEN
PROPOSED LOCATION OF TREES CALLED FOR ON THE PLANS AND ANY
UNDERGROUND UTILITIES OR SUBSURFACE STRUCTURES. INSTALLER SHALL
NOTIFY ARCHITECT OF ANY CONTINON THAT WOULD PREVENT THE HEALTHY
OF THE STANDARD AND ACCEPTANCE OF THE PLANTING
OFFICIAL TAWARD. ALL LANDSCAPE AREAS AND GRADED SWALES ARE TO
BE SODDED WITH FLORATAM UNLESS NOTED OTHERWISE. THE GROUND IS
SHALL BE A CRISP LINE SEPARATING PLANT BEDS FROM ALL SOD AREAS.
SOD TO BE STANCED AS NECESSARY TO PREVENT FERGOSON. CONTRACT OF THE STANDARD OF THE PLANT OF THE SHALL BE A CRISP LINE SEPARATING PLANT BEDS FROM ALL SOD AREAS.
SOD TO BE STANCED AS NECESSARY TO PREVENT FERGOSON. CONTRACTOR
TO SOD ALL DISTURBED AREAS DUE TO PROPOSED CONSTRUCTION.

PLANTING SOILS: ALL PLANTING PITS SHALL BE BACKFILLED WITH TOPSOIL MI CONSISTING OR FIFTY (50) PERCENT SAND, FORTY (40) PERCENT MUCK AND TEN (10) PERCENT HUMUS OR PEAT, BY VOLUME, WELL MIXED WITH APPROPRIATE FERTILIZER ADDED.

- MULCH: ALL EXPOSED AREAS IN PLANTING BEDS, INCLUDING HEDGE ROWS, SHALL BE KEPT WEDD FREE AND MULCHED TO A MINIMUM OF THREE (3) INCHES DEPTH, EXCEPT THAT TWO (2) INCHES SHALL BE REQUIRED IN ANNUAL BEDS. MULCH SHALL BE REPLENSHED, AS NEDDED, TO MEET THIS REQUIREMENT.

TESTING SCHEDULE GUIDE

ПЕМ	TEST TYPE	TEST I.D.	REQUIREMENTS	FREQUENCY
EMBANKMENT	MAXIMUM DENSITY OPTIMUM MOISTURE FIELD DENSITY	AASHTO T180 ASTM D1557 AASHTO T191, T204, T238 ASTM D1556, D2937, D2922	N/A 95% OF MAXIMUM DENSITY	PER SOIL TYPE ONE PER 2.500 S.F. HORZONTALLY *, ALTERNATING LIFTS (12")
UTILITY TRENCH BACKFILL UNDER ROADWAYS AND STRUCTURES	MAXIMUM DENSITY OPTIMUM MOISTURE FIELD DENSITY	AASHTO T180 ASTM D1557 AASHTO T191, T204, T238 ASTM D1556, D2937, D2922	N/A 95% OF MAXIMUM DENSITY	PER SOIL TYPE ONE PER 2,500 S.F. HORIZONTALLY EVERY 2' VERTICALLY D2922 — AT LEAST ONE FOR EACH PIPE RUN
BACKFILL OF STRUCTURES	MAXIMUM DENSITY OPTIMUM MOISTURE FIELD DENSITY	AASHTO T180 ASTM D1557 AASHTO T191, T204, T238 ASTM D1556, D2937, D2922	N/A 95% OF MAXIMUM DENSITY	PER SOIL TYPE ONE PER 2,500 S.F. EVERY 2' VERTICALLY
SUBGRADE	BEARING VALUES MAXIMUM DENSITY OPTIMUM MOISTURE FIELD DENSITY & THICKNESS	LBR — FLA. D.O.T. AASHTO 1180 ASTM D1557 AASHTO 1191, 1238 ASTM D1556, D2922	LBR = 40 MIN. N/A 98% OF MAXIMUM DENSITY	ONE PER SOIL TYPE CHECK POINT LER AT SOO LF, HORIZONTALLY ONE PER SOIL TYPE ONE PER 2,500 S.F. HORIZONTALLY
BASE	BEARING VALUES MAXIMUM DENSITY OPTIMUM MOISTURE THICKNESS FIELD DENSITY GRADATION ATTERBURG LIMITS	LER — FLA. D.O.T. AMSHTO T180 ASTM D1557 AASHTO 1191, 1239 ASTM D1556, D2222 AMSHTO 1237, T98 ASTM C136, D423, D424	LBR = 100 MIN. N/A 98% OF MAXIMUM DENSITY PER SPECIFICATIONS	ONE PER SOURCE OR AS MATERAL CHANGES CHECK POINT LER AT 500 LF. HORIZONTALLY ONE PER SOURCE ONE PER 2,500 S.F. HORIZONTALLY ONE PER SOURCE
SOIL CEMENT BASE MIX DESIGN (TO BE USED IF SEPARATION BETWEEN SHWT AND BOTTOM OF BASE IS < 1.5')	PORTLAND CEMENT ASSOC. SPECIFICATIONS MAXIMUM DENSITY OF THE COLLEGE STRENGTH SPECIMENS IEST LORES FIELD DENSITY & THICKNESS	AASHTO TIJ4 (STANDARD) FORTLAND CEMENT ASSOC. SPECIFICATIONS PORTLAND CEMENT ASSOC. SPECIFICATIONS ASSHOT 1911, T238 ASTM D1556, D2922	PER SPECIFICATIONS N/A 300 PSI AT 7-DAYS TYPE DAILY ** 450 PSI AT 21-DAYS SET OF COMPRESSIVE ** 95% OF MAXIMUM DENSITY	ONE PER SOIL TYPE ONE PER SOIL TYPE DAILY ONE SET OF 3 PER SOIL TYPE ONE SET OF 3 PER SOIL TYPE ONE PER 2.500 S.F. HORIZONTALLY
ASPHALTIC CONCRETE	MATERIALS QUALITY BITUMEN CONTENT GRADATION FIELD DENSITY COMPACTION LOS ANGELES ABRASION THICKNESS	AASHTO T184 ASTM D2172 ASTM 02950-81 AASHTO T96-77 ASTM C131-81 N/A	PER SPECIFICATIONS 95% OF LAB DENSITY 95% OF MARSHALL MAXIMUM UNIT PER SPECIFICATIONS PER SPECIFICATIONS	ONE PER DAY ONE PER 2,500 S.F. HORIZONITALLY ONE PER SOURCE ONE PER 2,500 S.F.

* THE CONTRACTOR SHALL NOT PAVE OVER SOIL CEMENT BASE UNTIL A 30-DAY CURING HAS ELAPSED.

NOTES:

** MAXIMUM STRENGTH LIMITS, AS ESTABLISHED BY SOILS TESTING COMPANY, SHALL NOT BE EXCEEDED SHOULD ANY OF THE INFORMATION PROVIDED HERBIN CONFLICT WITH EITHER THE REGOMENDATION OF THE GEOTECHNICAL ENGINEER, AND/OR THE GEOTECHNICAL REPORT, THEN THE AFOREMENTED RECOMMENDATIONS WILL SUPPERCEDE THIS "TESTING SCHEDULE GUIDE".

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ISSUE DATE: 02-23-16

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CONTRACT DATE: July 20, 2004

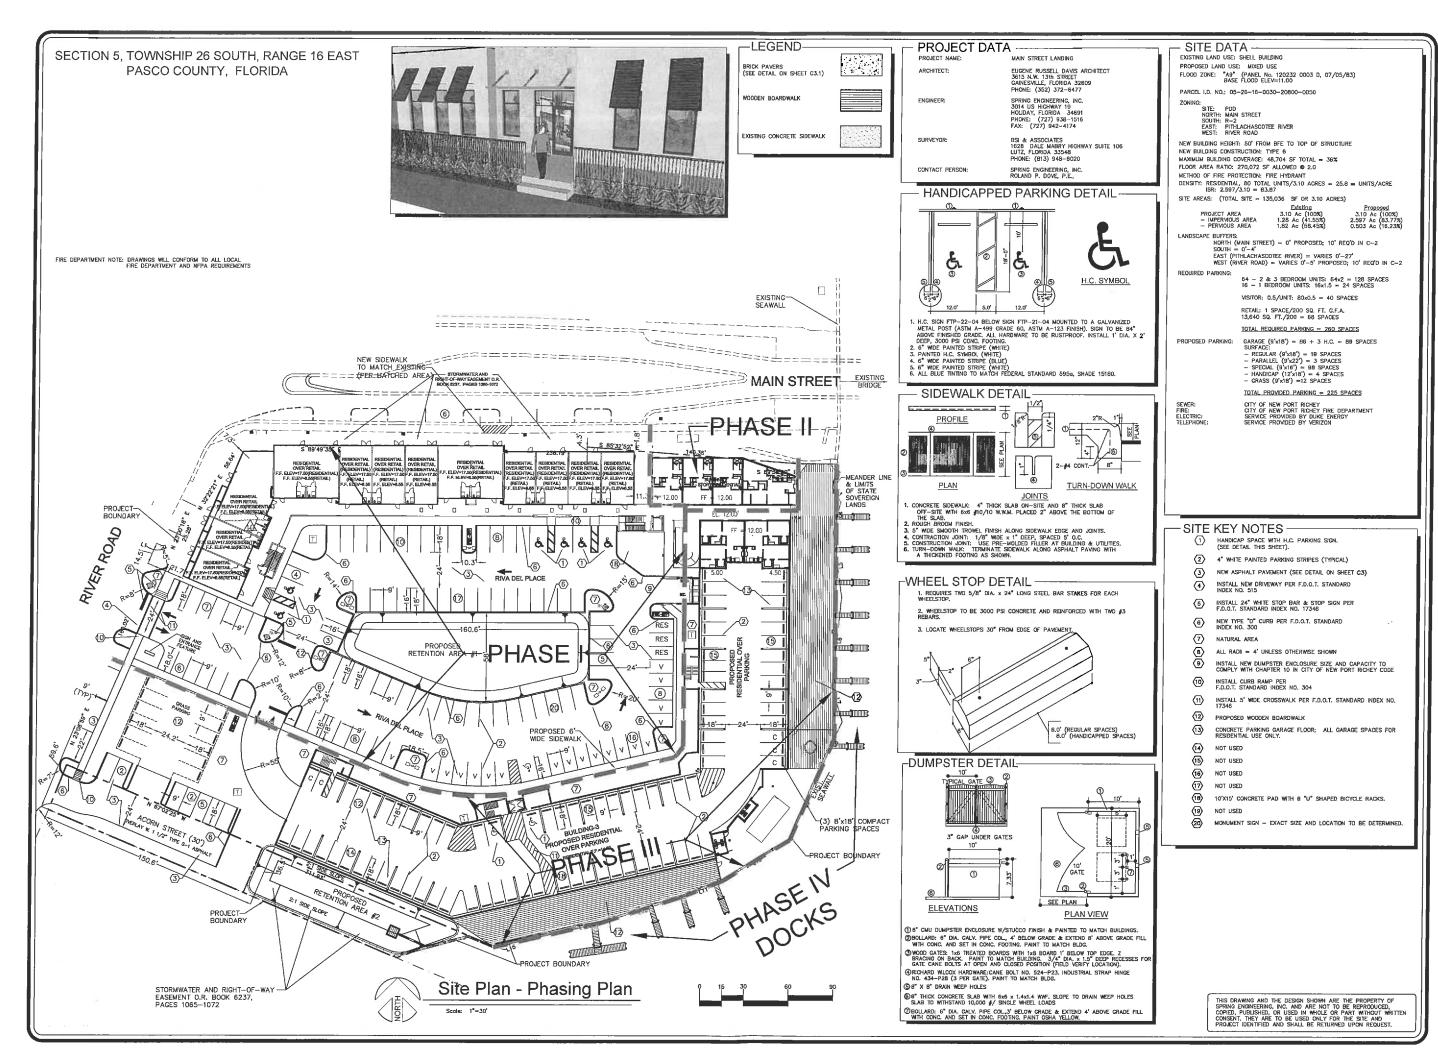
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NOTES & SPECIFICATIONS

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STAGING EXHIBIT

DRAWN BY: JPE CHECKED BY: RPD 08 NUMBER 2004-26

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NPDES NATIONAL POLLUTION DISCHARGE ELIMINATION SYSTEM **EROSION CONTROL NOTES**

THE FOLLOWING NARRATIVE DE THE STORMINATER POSILITION PREVENTION PLAN CONTAINS REFERENCES TO THE FOOT STANDARD SPECIFICATIONS FOR ROAD AND BRIDGE CONSTRUCTION, THE DEVICE STANDARDS AND OTHER SHEETS FOR THESE CONSTRUCTION PLANS CRAISE. THE CONSTRUCTION PLANS CRAISE OF THE CONSTRUCTION PLANS CRAISE OF THE CONSTRUCTION PLANS CRAISE. THE CONSTRUCTION PROPERTY CONTRIVERS AN INDEX. TO THE TOTAIN SHEETS THE CONSTRUCTION AND TO THE CONTRIVER COMMINIOR PROPERTY OF THE CONTRIVENCE OF THE CONTR

SITE SPECIFICATION PROJECT INFORMATION

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CONTROLS

ENCINCIA AND REDMENT CONTROL MEASURES ARE TO BE FLACED FROM TO, OR AS THE TIRST STEP IN CONSTRUCTION, THE CONTRACTOR IS RESPONSIBLE FOR COME, TING WITH ALL EROSION CONTROL MEASURES SHOWN ON THE FLACE THE EROSION CONTROL SYSTEM DISSIONED WITHIN THE CONSTRUCTION OCCURRENT SECURIO BE CONSIDERED TO REPRESENT THE MINIMOUS ACCEPTABLE STANDARDS CONTROL MODERN THE STANDARD AS RECOURSED DEPOSITIONED THE STANDARD CONTROL MEASURES BY A BE RECOURSED DEPOSITIONED THE STANDARD EVENT OF THE RAMPAUL EVENT ANDOR AND DESVED INDECESSARY AS A RESULT OF ON SEE PASSECTIONS BY THE APPLICABLE UNREDUCTIONAL AUTHORITION. THE SEVENT OF THE APPLICABLE UNREDUCTIONAL AUTHORITION ESTANDARD ON THE SEVENT OF THE APPLICABLE UNREDUCTIONAL AUTHORITION ESTANDARD ON THE SEVENT OF THE SEVENT OF THE APPLICABLE OF THE OWN THE SEVENT OF THE SEVENT

REQUIRED WILL BE SITE AND PLAN SPECIFIC. THEY SHOULD BE SIMPLOTED PRICKLIFO ANY CONSTRUCTION ACTIVITY.

NEXICAVATED MATERIAL WILL NOT BE DEPOSITED IN LOCATIONS WHERE IT COLLID BE WASHED AWAY BY RICH WATER OF STORM WINTER REPORT STOOMS EDMATERIAL SHALL BE COVERED OR EXCHANGE ON ANTH SEGMENT ON TAXIMIENT REVIOUS

DISTAR, (ZATITAL MEASURES RAAL), SE INITIATED FOR ERDOUGH AND DEDUMENT CONTROL CISTI ISSEN ARRIGATION OF THE STREAM SHOWS HERE OF THE METER AND SERVING CONTROL DISTRIBUTION OF THE ARREST AS SCORES PROJECTLY AD TWITTEN HAVE TRINGFARMLY OR PERMANENTLY CRASED CLEARED SITE DEVELOPMENT ARRESTMING WILL FEMANE AT ROUGH CRAME FOR AT MAY GO MORE PROJECT OF THE MORE STREAM AT ROUGH CRAME FOR AT MAY GO MORE PROJECT OF THE MORE STREAM AT THE SUFFICIENT TO STREAM THE ALECTION AND THE SUFFICIENT TO STREAMS THE ENDICHARY ORDINECOVER ORS: THE USE OF AN ANTROMINES AS SERVATIVE BY

4 PLL CRASS SLOPES CONSTRUCTED STREETER THAN 4H IV SHALL BE SOCIED IMMEDIATELY AFTER FINAL CRADE IS ESTABLISHED.

SWHERE REQUIRED TO FREVENT ERCEION FROM SHEET FLOW 4CROSS BARE DROUND FROM ENTERING A LAKE ON SWALE A TEMPORARY SECHNON GUMP SHALL BE CONSTRUCTED. THE TEMPORARY SEDIMENT GUMP SHALL BEYARD IN FLACE UNTIL VEGETATION IS RETARDISHED ON THE CERCAND DANAISMED TO THE GUMP.

INCOMENTAL PROPERTY AND ERRORDING CONTINUE MEASURES FOR ALL SLOPES, CHANNELS DITCHES OR ANY OPERATIONS TOWN DRAW STATE OF THE OPERATION OPERATION OF THE OPERATION PROTECTION SHALL BE MAINTAINED UNTIL PERMANENT MEASURES ARE IN PLACE AND ESTABLISHED

PROTECTION OF SURFACES WATERS TIMPESE PRACTICAL STORMWATER SHALL PERCONVEYED BY MULES SHALLS SHALL SE CONSTRUCTED AS SHOWN ON PLANS

DEACOION CONTROL MEASURES SHALL BE EXPLOYED TO MINIMIZE TURBUITY OF SURFACE WATERS LOCATED POAMSTREAM OF ANY CONSTRUCTION ACTIVITY WHILE THE VARIOUS MEASURES REPORTED WILL BE DITE SPECIFIC THEY SHALL BE EMPLOYED AS MEDIED IN ACCORDANCE WITH THE CALL CAMED.

SINGENERAL EROSONISHAIR DE CONTROLUED AT THE ELIKHERT FRACTICAS DIFERENAS CONTROL

NEW AND EXISTING STORMWATER IN FTE AND OUTSALL STRUCTURES SAME RE PROTECTED DURING COMS INJUSTION PROTECTION MEASURES SHALL BE EMPLOYED MEASURES OF CONSTRUCTION. A PERIMETER EROSION CONTROL DENICES SHARL REMAIN IN FLACE UNTIL TIMAL SITE. STABILIZATION HAS BEEN ESTABLISHED

SHEAVY CONSTRUCTION SOLSPIMENT PARKING AND MAINTENANCE AREAS SHALL SE DESIGNED TO PREVENT OIL ORGANE AND CLUSINGARTS PROD STITZENIG STE DRAWASS PENTURES INCLUDING STORMANTER COLLICTION AND TRANSMENT SYSTEMS CONTRACTORS SHALL PROVIDE SYCAS DRESS OF SITS AS FERDERS AROUND FROM FROM PRINTER WITHIN SYSTEMS CONTRACTORS SHALL HAVE AVAILABLE OF OIL ORGANS LUSPICATION OR CTURE CONTAMINANTS CONTRACTORS SHALL HAVE AVAILABLE AND SHALL USE ARROUNDED TO THE PADS TO CLEAN UP CRILLS IMMEDIATELY AFYER ANY OCIUMNOCIE

STORMMATER MANAGEMENT.
THE CONTRACTOR IS REQUIRED TO INSPECT AND MAINTAIN CONTRACT, WEERLY AND WITHIN AN HOURS.
WHERE A RAINTORN IN EXCESS OF DISINICHES THE INSPECT ON REPORTS OHALL BE SIGNED BY THE
INSPECTOR AND CONTRACTOR AND MAINTAINET FOR FUTURE, BEFFARING, IS INSECTED. THE
INSPECTOR AND CONTRACTOR AND MAINTAINET FOR FUTURE, BEFFARING, IS INSECTED. THE
INSPECTOR SHALL REPORT ALL HISSESTED IN THE MAINTAIN AND CONTRACT THAT THE TABLE THE
INSPECTOR WHITE EAR QUALIFIED ERIOSION AND EDITINENT COMINCE INSPECTOR AS DEFINED BY THE FLORIDA DEPARTMENT CHEFA ROTARINAL PROTECTION

REFERENCES
IT IS THE CONTRACTOR'S RESPONSISHTY TO FILE INDICE OF INTERFIT TO USE GENERIC PERMIT FOR STORMARTIS DISCHARGE FROM CONSTRUCTION ACTIVITIES (DEP FORM ROACT STORAGE) IN LATEST VERSION) TO FED TO THE FOLLOWING ACCRESS PROMING ACT STORAGE SCHARE, MAY SUSTIFICATED THE ACTIVITIES (DEPARTMENT OF SINVERDIMENTAL, PROTECTION SOS DAIRS FORMER SON DEPARTMENT OF SINVERDIMENTAL, PROTECTION SOS DAIRS FORMER SON DEPARTMENT OF SINVERDIMENTAL, PROTECTION SOS DAIRS FORMER SON DEPARTMENT OF SINVERDIMENTAL PROTECTION SOS DAIRS FORMER SON DEPARTMENT OF SINVERDIMENTAL PROTECTION SOS DAIRS FORMER SON DEPARTMENT OF SINVERDIMENTAL PROTECTION SON DEPARTMENT OF SINVERDIMENT OF SINVERDIMENT

MATERIAL MANAGEMENT PRACTICES
THE FOLLOWING ARE THE MATERIAL MANAGEMENT PRACTICES THAT SHALL BE USED TO REDUCE THE RICK OF THE SPILLS AFTER A CODENTAL EXPOSURE OF STORY WATER RUNG

GOOD HOUSEKEEPING THE POLLOWING GOOD HOUSEKEEPING FRACTICES SHALL SE FOLLOWED ON SITE OUTING THE CONSTRUCTION PROJECT, AN OFFICER SHALL BE MADE TO STORE ENQUOR PRODUCTS OR COMPLETE. THE PROJECT, ALL MATERIALS STORED ON SITE SHALL BE STORED IN A NEAT, ORDERLY MANNER IN HER APPROPRIATE CONTAINERS AND IF COSTOLE KEPT IN THE ORIGINAL MANUFACTURERS ABFIET CONTAINERS FURSTANCES SHALL NOT BE SIXED WITH ONE ASSITED UNLESS HELDIMMENDED BY THE MAINLEACTURER, WHENEVER POSSING ALL THE MANUFACTURER'S PEDDIMMENDATION FON PROPER USE AND DISPOSAL OF MATERIALS (IN SITE

HAZARDOUS PRODUCTS
THISE PRACTICES ARE USED TO REDUCE THE HIGHS ASSOCIATED WITH HAZARDOUS MATERIALS
PROCESTES AND SEKEPT HIGHGINAL CONTINUES UPLESS THEY ARE NOT REUBABLE ORIGINAL
LABBLE AND MATERIAL SAFETY DATA SHALL BE HETAINED THE CONTAIN IMPORTANT PRODUCT
RECORMATION IF BURYLUS PROCULT MUST BE DISPOSED OF MANIFACTURER'S OR LOCAL STATE
RECOMMENDATION METHODS OF PROPER DISPOSAL SHALL BE POLLOMED

PETROLEUM PRODUCTS ALL SZIE VEHCLES SHALL BE MONITORED LEAKS AND RECEIVE NEGLEAR PREVENTATIVE MAINTENANCE TO REDUCE THE CHANGE OF LEARADE LABELED ANY ASCHALT SUBSTANCES USED ON SITE SHALL BE AFFLIED ACCORDINGLY TO THE MAINLEAGTURER'S RECOMMENDATIONS

FERTILIZERS
FERTILIZERS USED SHALL SE AFFL'ED OR YINTHE MIRIMUM AMOUNT RECOMMENDED BY THE MANUFACTURER ONCE AFFILIED FERTILIZER SHALL BE MONKED INTO THE GOLT TO LIGHT EXPORAGE TO STORM WATER. STORAGE SHALL BE IN A DISCREDIBLING THE CONTENTS OF ANY PARTIALLY USED SHAD SHALL BE TRANSPERRIED TO A SEALABLE PLANTED BY TO AVIOLOGY.

PAINTS
ALL CONTAINERS SHALL BE LIGHTLY SHALED AND STORED WHEN NOT REQUIRED FOR USE, EXCESS. ALL CONTINUES SIMIL BE LIGHTLY SYMALD AND STOKED WHEN NOT RECORDED FROM ERACES.

PARM SHALL NOT SE DISCIRIAGED TO THE STORM SERVER SYSTEM BUY SHALL BE PROPERLY DISCRESSED OF ACCORDING TO MANAFACTURER'S INSTRUCTIONS OR STATE AND LOCAL REGULATIONS CONCRETE TRUCKS DOWNARD TOR SHALL DEGREATED AN AREA PER DECOMPACTED SHALL OF CONCRETE OR DRIVE WAS AWATER AND SHALL INSTALL A CONTINUENT SERVER AROUND THIS AREA TO PREVEN DOWNER FOR THE ERAMINDER OF THE SITE MAND DESIRES SHALL SE DISPOSED OF SY A CONTRACTOR LIPON COMPLETION OF THE PROVECT.

SPEL CONTROL PRACTICES
IN ADJITION TO THE GOOD HOUSEKEEPING AND MATERIAL MANAGEMENT FRACTICES DISCUSSED IN
THE PREVIOUS ABOTTOM OF THIS PLANTIC FOLLOWING PRACTICES SHALL SE FOLLOWED FOR SHILL PREVENTION AND CLEANUE I MANUFACTURER'S RECOMMENDED METHODS FOR SPILL CLEANUP SHALL BE CLEARLY POBED AND OF PERSONNEL SHALL BE MADE AWARE OF THE PROCEDURES AND LOCATION OF THE INFORMATION

I MATERIALS AND FOREPUENT RECESSARY FOR SITEL CLEARNIP SHALL BE KEPT IN THE MATERIAL STORAGE AREA ON SITE BOMPMENT AND MATERIAL SHALL INCLUDE BUT NOT UNITED TO ERROMS CUST MAIS MOPS RAGE GLOVES SOGGLES, KITTY LITTER SAND SAW DUST ARE PLASTIC AND METAL TRAIN CONTAINERS.

3 ALL SPILLS SHALL DE CLEANED UP IMMEDIATELY AFTER DISCOVERY

4 THE SPIEL SHALL BE KEPT WELL VERTHATED AND PERSONNEL SHALL WHAR APPROPRIATE PROTECTIVE CLOTHING TO PREVENT HAUR? FROM CONTACT WITH HAZARDOUS SUBSTANCE

5 24/11/15 OF TUXIC OR HAZARDOUS MATERIAL SHALL BE HEPORTED TO THE APPROPRIATE STATE OR LOCAL GOVERNMENT ASSENCE REGARDLESS OF THE SIZE

6 THE SPILL PREVENTION FLAN SHALL BE ADJUSTED TO INCLUDE MEASURES TO MISSENT THIS TYPE. OF SPLL FROM RECOCUSAING AND THE CLEARUF FROCEDURES FOR FUTURE USE A DESCRIPTION OF THE SPLL, IT'S CAUSE AND THE CLEARUP MEADURES SHALL BE INCLUDED.

THE SITE SUPERINTENDENT RESPONDING FROR THE DAY TO JULY STELDERATION WHALL RETHE SPILL PREVENDED AND QUEANUP COCRDINATION HE OR SHE SHALL INSIGNATE ON HER SITE PURPOCAND. FOR WILL RECEIVE SHILL PROPERTION AND CLEAN UP THOSEN MOVINDUALS SHALL EACH RECOVER RESPONDING HE FOR A PARTICULAR PHASE OF PREVENTION AND CLEAN UP THE MAINS OF THE PREPONDING ESTALL PEROLUCIAL CHAIL BY FOSTED IN THE MATERIAL STORAGE AREA OR IN THE OFFICE TRAILER ON SITE IF AFFICAGE.

WASTE DISPOSAL.
WASTE MATERIALS, ALL MATERIAL SHALL DE COLLECTED AND CONTAINED RILA CONTROLLED ASSA
PARGMANT TO STATE AND LOCAL SIZE WASTE REDILATION ALL TRASH AND CONSTRUCTION DEBRIS
CONSERVORM SHALL BE BUSIED ON DITE ALL PERSONNEL SHALL BE INSTRUCTED RECARDING THE
CONFECT PROCEDURE OF WASTE DISPOSAL. NUTICES STATING THESE PRACTICES SHALL BE POSTED.
IN THE DIGHTE CONSTRUCTION TRAILER AND THE CONSTRUCTION MAYAGER RESPONSIBLE FOR THE
DAY TO DAY TO THE OPERATIONS SHALL BE RESPONSIBLE FOR SERVICE SHALL BE RECEDED.

FOLLOWER PARAMETER IF DICTURITIESD, ALL WASTE MATERIALS SHALL BE DISPOSED OF BUTHE MAINING SPECIFIED BY STATE AND LOCAL REQUARTIONS. THE CONTRACTOR SHALL BE RESPONSIBLE FOR SEMINOR THAT THEIR SHACKNESS SEAS POLICIONS.

SANITARY WASTE AND CANTARY CRAFT WASTE SHALL BE COLLECTED FROM PORTABLE UNITS BY A LUCKISED SANITARY WASTE MANAGEMENT DOMINAL TOR AS REQUIRED BY STATE AND LOCAL CODE.

CONTROL OF WINE BROSKIN.

1 BARE 658TH ARREAD SHALL BE WATERED DURING CONSTRUCTION AS RECEBBARY TO MINIMAZE THE
TRANSPORT OF FURDING BUDS IT MAY BE NET SSSARY TO LIMIT CONSTRUCTION VEHICLE SPEED IN
BARE BARTH HAR NOT BEEN EFFECTIVED. YEAR FERD, IN NO CASE SHALL FURTHER BLAST SE ALL DWEN
OF THE THE SITE LUCERS CONSTRUCT OF
THIS RECEIVED AFTER CORRECTIVE OF CONSTRUCTION, BARE SARTH SHALL BY VEHETATED
AT BAY TIME BOTH DURING AND ARTER OF ECONOMINACTION THAT VEHTERING ALLDOW VEGETATIVE
ARE NOT STREETING AS CONTROLLING WIND EXCOURTANCED THAT VEHTERING ALLDOW VEGETATIVE
WAS RECEIVED AND CONTROLLING WIND EXCOURTANCED THAT VEHTERING ALLDOW MAY
WING LIBE BROSKING TO FURTHER SHALL BE THE CONSTRUCTION OF MUSIC SHALL BE
CONSTRUCTED IN ACCORDANCE WITH THE DETAIL FOR A SILL REPORT EXCEPT. THE BINISTING PORCHT

SHALL BE A FEEL IN A POINT TO THOSE RECEIVERED CUTLINED WITHIN THE CONTITUCTION PLANE AND DOCUMENT'S THE CONTINEOTOR SHALL BE RESCONDEDE FIGHT THE FOLLOWING WEIGHTED INFROMET SCHEDULT WITH ERCOON AND SEDMENT CONTROL WETELLATER AND MAINTENANCE TIES TO SPECIFIC DATEBUR CONTITULITION ACTIVITIES.

WALTERATIONS TO THE DESIGN PROSECTS AND SECURENT CONTROL BIDGE TO DIFFERENCES NETWEEN THE DESIGN PLANS AND ANTICIPATED CONSTRUCTION FRASING AND THE CONTRACTOR & CONSTRUCTION METHODS TANK AND THOSE TUMBER OF CONTRACTOR & REPRESENTATIVE FOR ERCISION AND

ENDMENT BY DECISION MAKER OF CONTRACTOR IS ROPRESENTED FOR ERCISION AND BEDMENT BY TALLATION AND MAINTENANCE ON A 24 HOUR BASIS OFFICE CONTRACTOR WILL FURNISH, INSTALL MINITARY AND QUESTIONINT, THE CONTRACTOR WILL FURNISH AND NOTALL ALL RECUSSARY PERMANENT BOOKING CONTRACTOR WILL FURNISH AND NOTALL ALL RECUSSARY PERMANENT BOOKING CONTRACTOR WILL FURNISH AND NOTAL ALL RECUSSARY PERMANENT OF THE AND CONTRACTOR WILL FURNISH THE CONTRACT OF THE AND NOTAL STORMARY MAKES FERTILIZED A PROTOCOLE BOOKING OF ADMINISTRATION OF MACANCOLE OF THE CONTRACTOR BIOCATOR PROCEDED BY THE PROJECT ENGINEER OFFICIAL OF WASHINGTON OF MACANCOLUS AND FEDERAL AND NOTAL STORMAN MACANCOLUS AND FEDERAL AND OWNED THAT THE CONTRACTOR IS A PURPOSED THAT THE CONTRACTOR IS AND ADMINISTRATION OF THE CONTRACTOR OF THE CONTRACTOR OF THE CONTRACTOR OF THE PURPOSED IN THE CONTRACTOR OF THE CONTRACTOR OF THE CONTRACTOR OF THE CONTRACTOR AND ADMINISTRATION OF THE CONTRACTOR OF THE CONTRACTOR

OVERNO PARCHI CIR RECEIVING WATER

TEMPORARY GRAVEL CONSTRUCTION ENTRANCE & EXIT

DEFINITION

A STONE STABILIZED FAD LOCATED AT FORM 6 OF VEHICULAR INSKILISS AND EGRESS ON A

CLANGES.
TO STABILIZE ENTRANCES TO THE CONSTRUCTION SITE AND REDUCE THE AND ANT OF SECURENT TRANSPORTED ONTO PUBLIC ROADS BY MOTOR VEHICLES OR RUHOFF.

CONDITIONS WHERE PRACTICE APPLIES
WHEREVER TRAFFIC VIILL BE LEADING A CONSTAUCTICALS TE AND MOVING DRIVETLY COLTO A PUBLIC
READ OF OTHER PROPER PRESE

PLANNING CONSIDERATIONS
CONSIDERATION SUPPRISONS PROVIDE AN AREA WE FIR MUCHON BE RIMOVED FROM CONSTRUCTION
CONTRICTION ENTRANCES PROVIDE AN AREA WE FIR MUCHON BE RIMOVED FROM CONSTRUCTION
CHIEF THE GRAVEL WILL BIND SUPPRISONS TO PRINCIPLE MOST OF THE MUCH THE TIRSE MUST BE
WASHED SERONE THE VEHICLE ENTERS A PUSIC ROAD IF WASHIND IS USED. PROVIDING MUST BE
WASHED SERONE WASHINGTON AND WASHINGTON AND TRAIT HE SERVING ITS CONTRICTED TO READ OF STE
CONSTRUCTION ENTANDESS SHOULD BE USED IN COMMITTED AT THE STRUCTURE OF THE PROVIDERS OF THE PROVIDER CHARRACTION YOACA TO RECUCE THE AMOUNT OF AUCUPICKED UP BY CONSTRUCTION VEHICLES. DESIGN CRITERIA

AGGREGATE SIZE
FIGHT NOT COVARIE A CORRIGATE (1.5 - 2.5 NOTH STONE) SHOULD BE USED WOOD CHIPS MAY BE USED
FIGHT SHOWS FROM A PRESIDENTIAL CONDITINICTION. PROVIDED THAT THEY CAN BE PREVENTED FROM
FLOATING AWAY IN A STORM.

ENTRANCE DIMENSIONS
THE AGGREGATE CAPER MUST BE AT LEAST SANCIARS THICK, IT MUST BE FULL WIDTH OF THE
VEHICLURE MARKES AND ESSMESS AREA. THE LEMBTH OF THE ENTRANCE MUST BE AT LEAST SO FER!
THE ENTRANCE MUST WIDEN AT ITS CONFECTION TO THE ENGINEEY BY CHOICE TO ACCOMMISCIATE THE
TURNING REVULS OF LEAST TRUCKS.

SILT FENCE

DEFINITION
A TEMPORARY SEDMENT BARRIER CONDISTING OF A FABRIC STRETCHED ACROSS AND ATTACHED TO A TEMPORARY SEDMENT BARRIER CONDISTING OF A FABRIC STRETCHED ACROSS AND ATTACHED TO SUPPORTING POINTS AND ENTERPORARY LINEAR PLATER BARRIER CONSTRUCTED OF SYNITHESIS HETER FABRIC POINTS AND DEPENDING UPON THE STRETCHED ACROSS AND DEPENDING UPON STRETCHED ACROSS AND DEPENDENCE UPON STRETCHED ACROSS AND DE

PURPOSES
1 TO WITEROST AND DETAIN SHALL AMOUNTS OF SECURENT FROM DISTURBED AREA QUIENG CONSTRUCTION DESALTONS
2 TO DECREASE THE VELOCITY OF SHEET FLOWS AND LOW TO MODERATE LEVEL CHARGE. IT ONS

2. TO DESCREAME THE VELOCITY OF SHEET FLOWS AND LOW TOWNCHARM FLOWER, CHAMMER, NOWS-CONDITIONS WHEN PRACTICES APPLIES.

1. BELOWDISTURBED AREAS WHERE ERICS ON WOLLD OCCUR HIT HE FORM OF SHEET AND ALL.

FORMOUS 1. WHENE THE REQUEST OF THE DIRATIANS AREA IS NOW NOW IT HAS THE APPLIED FOR THE BELOW FLOW OF THE MAINTH SLOPEL ENDITH EMBRID THE PARTIES IS 100 PEET, AND THE MATIMUM ORDIDIES OF BEHAVIOR HE WASHINGTON THE WARRINGTON ORDIDIES.

3 IN MINOR SWALES ON DITCH LINES IN IERE THE MAJERLIN CONTRIBUTING THE DRAINING AREA IS NO

GREATER THAN DIACRES
4 UNDER NO OPPOLITISTANCES SHOULD SUT FEWES BE CONSTRUCTED IN LIVE STREAMS OR IN SWALES OR CITCH LINES WHERE IT OWN ARE LIKELY TO EXCEED CHECUBIC FIXOT HER SECOND (CESS-SEE CESSUS CRITERIA FOR FURTHER CLARIFICATION

PLANNING CONSIDERATIONS
SELF PENCERS CAN TREFF A WICH HIGHER PENCENTAGE OF BUSINESS BECAMENTE THAN CONSISTINATE AS A STANKE RATE OF BUSINESS AND LONGE THAN THAN TO STANK BARRIERS THE FALLISE RATE IS SITE. OF BRAINE, TO STANK BARRIERS THE FALLISE RATE IS SITE. OF BRAINE, FOR MARRIERS THE PROTECTION TO STANK BARRIER TO STANK BARRIERS THE FALLISE RATE IS SITE. OF BRAINES, SET FEMILIES SPECIES AS WINDOWS OF THE PROTECTION OF THE DESTINATION OF THE PROTECTION OF THE DESTINATION OF THE PROTECTION OF

BARRIERS ARE MEXICONOMY STRUCTURED COMPOSED OF BUGLAP OR STANDARD WEIGHT E-MTHETIC FILTER PASSED STAIN ON NO MACHINEN COMPOSED. TER PASSIC STAPLED TO MODDEN STARRS FLOW RATES THIS DUSH BURL AF TELLS BARRIERS A BURLY SLOWER AND FLOWING STROUGH OF IS SYMPTICANTLY HIGHER THAN FOR STRAW PALE.

SILT FENCES COM OUR), OF A WARE SUPPORT FENCE AND AN A TRICHED SYNTHETIC FILTER HABRIC. SLIT FENCES COMINGER OF A WINE SUPPORT FENCE AND AN ATTRICHED SYNTHETIC PILITER PARKS SUM THE ROW RATE STORMINGHAMT, REST HAVE A HORBER RETERING SERVICIEST THAT BURILLA BOTH MOVEN AND JOHNACYEN SYNTHETIC MERICIS ARE COMMERCIALLY AVAILABLE. THE WOVEN FARRICAS ENFERRALLY DUENTAL HIGHER STREMITH THAN THE MEANINGHER FARRICS INCHEASE IN STREMITH THE REST AND AND THE MOVEN THAN THE MOVEN FARRICS THE SAME IS THE OF TESTING WHERE RETERING THE ARYSINGER REASTON PREPARED THE TATE OF WAST RESERVOIS OF THE TARNIC THEY WAIL ALL OF THE FARRICS DEMONSTRATE VERY HIGH RETERING ETHICATION FOR NAME SECRETARY THERE IS CONDECEDED THE TOTAL OF THE PROPERTY OF THE PROPERTY OF THE OWN THAT HE ARROWS THE SAME OF THE PARKET O

NO PORMAL DESPITE IS REQUIRED FOR HAVING SNACE PROJECTS AND FOR MINOR AND INCIDENTAL APPLICATIONS DESIGNED TO RECOVER FOR MANY PROJECT STAND FOR MANY AND RECOVERY.

APPLICATIONS FOR CHANGE IN OW APPLICATIONS REFIRS TO DECUT STANDARD NIGHTS TOS CHART.

(FIRST, \$465) FOR CHOOSE ON RECOMMENDAD SPACING.

2 PRIFER ARAPPERS SHALL HAVE AN EXPECTED USABLE LIFE OF SHORTHS THEY ARE APPLICABLE IN

DITIDE LINES AND INSTRUCTION OF THE PARTY OF TEMPORARY LOCATIONS WHEN CONTINUOUS CONTINUOUS CONTINUOUS AND TEMPORARY LOCATIONS WHEN CONTINUOUS CONTINUOUS AND TRUMPS CHARACTERISTICS AND WHERE LOW ON MODIFIER FILMS CHARACTERISTICS AND WHERE LOW ON MODIFIER FILMS FROM TOKERS TO EXCEED AND CHARACTERISTICS AND WHERE LOW

THE MULEINAME PLOYER (NOT EXCEEDING LOFE) ARE EXPECTED.

1 BLT FRICKS SECULISE THEY HAVE MUCH LOVER PERMEASURY THAN BURLINFIN THE BARRIERS.

1 BLT FRICKS SECULISE THEY HAVE MUCH LOVER PERMEASURY THAN BURLINFIN THE HAVE ARRESTED BY COMMENTED BY COMMENTE

MATERIALS

1. SHATTER OF LITTER FASHIC SHALL BE PERVIOUS SHEET OF PROPYLENS MYLON FOLVESTEN. ON MICHELY ETHICLES YARD SYNTHETIC FILTER FARRIC SHALL CONTAIN (LITRAYIOLET RAY INHIBITIOSS AND STABLUZERS TO PRODUCE A SHAMMAN OF EXCENTES OF EXPECTED LIBRAY. E CONTRICTION LITERATA. TESPERATURE RANGE OF DECREES SHAMEHARD TO TUDE CREES FARRISHED. TO TUDE CREES FARRISHED TO LITERATE THE RANGE OF DECREES AND TO THE CONTRICTION OF THE OWNER WHEN THE TO TUDE CREES FARRISHED. TO THE SHAMMAN SHALL SEE THE A INCH DAMETER WOOD, OR 139 POWINDS PER LINEAR ROOT, STEEL WITH A MINIMUM LEUSTH OF SPEEL FORTS SHALL HAVE PROJECTIONS FOR PACIFICIAL WAY TO THE CONTRICTIONS.

4 STAKES FOR FILTER BARRIERS SHALL BE 1" X 2 WOOD (PREFERRED), OR COUNTAL ENTINETAL WATHA

MINIMUM LENGTH OF SIFEET s vare ferre reinforcament for bit ferces orang standard strength filter cloth shall BE A MINIMUM OF 36 INCHES IN HEIGHT OF 16 SAUGE AND SHALL HAVE A MAXIMUM MESH SPACING OF 6 MCHES

STORM DRAIN INLET PROTECTION

DEFINITION A SEDIMENT FILTER OR AN EXCAVATED INVITUNISING AREA AROUND A STORM DRAW DROP PILET OR

PURPOSE
TO PREVENT SEDMENT FOR ENTERING STORM WATER CONJECTANCE SYSTEMS FROM TO PERMANE
TO PREVENT SEDMENT FOR ENTERING STORM WATER CONJECTANCE APPLIES WHERE STORM
DIKKIN PILETS ARE TO SE MADE OFFERATIONAL BEFORE PERMANENT STABILIZATION OF DISTURBED
DIRAMACIE AREA DIFFERENT THIS SIZE STRUCTURES ARE APPLICABLE TO DIFFERENT CONDITIONS
AND CONJECTED AT THIS CONTROL OF STRUCTURES ARE APPLICABLE TO DIFFERENT CONDITIONS
AND CONTROL OF STRUCTURES AREA OF STRUCTURES AREA PROJUCTURES OF STRUCTURES AREA OF STRUCTURES AREA PROJUCTURES OF STRUCTURES AREA OF STRUCTURES A

PLANNING CONSIDERATIONS. STORM SEWERS WHICH ARE MADE OPERATIONAL REFORE THEIR CRAIMAGE AREA IS STABILIZED CAIL. STORM SEMERS WHICH ARE MADE OF ENTITIONAL BEFORE THEIR PRAMINGS AREA IS STABLIZED CAN COMPETATION AND MISS. IN CASE OF EXTERINE SEGMENT LOADING THE STORM SEMER LOCALING THE STORM SEMER LOCALING THE STORM SEMER LOCALING THE STORM SEMER LOCALING THE MAY CLOC AND LOCALING THE CAPACITY TO AND OTHER PROCESURS. IT IS NECESSARY TO REPERVENT SOMEWIT FROM ENTERING THE SYSTEM AT THE BURETS. THERE ARE SEVERAL TYPES OF MUST BE TERN AND TRANSPORTED WHICH HAVE DEFERRED APPLICATIONS DEFINANCE TO THE STORM THE SHAPE OF CONDITIONS AND TYPE OF RUET OTHER MINOVATIVE TS OFFICIALS AND ACCOMPLISHING THE SHAPE PURPOSE FOR ESCOLURACING SHOT ONLY RIFRES SPECIALS FURNISHED AND APPROVED BY THE STORM WATER THESE SPECIAL FUNDS AND DETAILS ARE SUBMITTED TO AND APPROVED BY THE STORM WATER PERMITTING ASMIC! NOTE THAT THESE VARIOUS INLET PROTECTION DEVICES ARE FOR DHAINAGE AREAS OF LESS THAN ONE ACRE NUMBER FROM LARGE DISTURBED AREAD SHOULD BE ROUTED THROUGH A TEMPORARY SED MENT TRAP SECTION 4 25 (ES DEP 115)

IMAM - SUCTION 4 ID US PAW 1 (2)
DESIGN CRITERIA

1. THE DRAINAGE AREA DIALL BE NO GREATER THAN LACRE

2. THE INLET PROTECTION DEVICE SHALL BE CONSTRUCTED TO PACALITATE CLEAN OUT AND DISPOSAL
OF TRAPPED BEDMENT AND TO MISMAZE INTERSERBICE WITH CONSTRUCTION ANTINCTES: 3. THE
HILLT PROTECTION DEVICES SHALL BE CONSTRUCTED SO THAT ANY REQUITATE PROMISE OF
STORMATTER WILL NOT CAUSE EXCESSIVE INCONVENIENCE OR DAMAGE TO ADJACENT AREAS ON
STRUCTURED. STRUCTURES

4. DESCRIB CRITERIA MORE SPECIFIC TO CALCH PRITICILLAR INLET PROTECTION DEVICES WILL BE
FOUND ON FLATER 4 08 481. CONTRUCTION SPECIFICATIONS

STRAW BALE DROP INLET FILTER I PALEN BHALL BE EITHER WIRE BOUND OR STRING THEO WITH BINDINGS ORIENTED AROUND THE T DICES ANTHER THAN COME AND LINES HE PALES.

2 PALES SHALL BE IN ACCOUNTED THE PALES.

2 PALES SHALL BE IN ACCOUNTED THE PALES.

3 PALES SHALL BE IN ACCOUNTED THE PALES.

4 PALES SHALL BE IN ACCOUNTED TO CONTINUE.

4 PALES SHALL BE IN ACCOUNTED TO CONTINUE.

3 THE FILTER BARRIER SHALL DE ENTRENCHED AND BACKFILLED A TREIX HI SHALL BE EXCAVATED 3 THE FILTER BARRIED SHALL DE DITTERNICHED AND GADIFILED A TREDICK INHALL BE EXCANTED.
ARGURET THE MILET THE WORTH OF A BALE TO A MIDIAMUN DESTRUCT A MIDIAMUN DESTRUCT HE THE BARE SHAD SHADE ATTER THE BARE SHAD SHADE AND COMPACTED A SHADES THE FILTER BARRIER.
A RADH HARE SHALL DE STOUDRELY AND ONCE AND HELD IN PLACE BY AT LEAST TWO STANES OR REBANDS DERIVED THROUGH THE BALE.
A LOOSE STANDS SHADE OF WINDINGS DETMEEN BALES TO PROPERTY WALTER FROM ENTERING BETWEEN BALES S. PRAYER MAY BE SHADE SHADE SHADE SHADE AND MIDD STANES OF THE BALES TO IMPROVE STANLING.

FABRIC DROP UNLET SEDIMENT FILTER

1 FABRIC SHALL BE CUT FROM A CONTINUOUS ROLL TO AVOID JOINTS.

2 STAKES SHALL BE I'X 4 "AVOOCUPREPERFED OR EQUIVALENT METAL WITH A UNRIMUM LEPOTH OF 2

FEET :

5 STAPLES BHALL SE OF HEAVY OUT? WIRE AT LEAST MUNCH LOWS

5 STAPLES SHALL SE SPACED AROUND THE PERMISHTER OF THE INLET A MAXIMUM OF 3 FEET APART
AND SECURIELY DRIVEN SHITCH THE GROUND MINIMUM OF 8 INCHES A FRAME OF T X Y WOOD RALE
AND TOSTS SHALL BE CONSTRUCTED AROUND THE TIPP OF THE STAKES FOR PROPER STABILITY. A TREMOH SHALL SE EXCEVATED APPROXIMATELY 4 SYCHES WIDE AND FINDHES DEEP AROUND THE OU SIDE PERMETER OF THE STAKES 5 THE BURLAN SHALL BE STATE OF THE WAYSTER STAKES, AND STAKES OF THE PARTY THAT I BY

EXTENDED INTO THE TRENCH THE HEIGHT OF THE FILTER BARRIER SHALL BE A MINIMUM OF 11 INC AND SHALL NOT EXCEED 15 INCHES

THE TRANCH CHALL BE BACKFILLED AND THE SOIL COMPACTED OVER THE BURLAP

SECTION 5, TOWNSHIP 26 S, AND RANGE 16 E.

CONSTRUCTION THE CA THE CA USINGES THE AP SCHOOL THE OR	ONDA MATER MANAGEMENT GISTRECT (CERTIFICATION) SOMERCE WATER MANAGEMENT PLAN (COMME) MORROUSTE OF FLAN SHEETS AND SHOWING ERROUGN PROTES OF ELUTILIZED OF THE PROTEST ASSETT HAS REVIEWED THE COMMPAND F ECOMPANIER REQUIRED SELLON ME CHALL SE FART OF THE FRINK COMSTRUCTION FLANS FOR THE PERMIT	is e
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TYPE		TITLE
SIGNATU	HE	DATE

CONTRACTOR CERTIFICATION

CONTRACTORS HAVE BEEN SELECTED

SPRING ENGINEERING INC.

LOST TO MORE PERATY OF LAW THAT I UNDERSTAND, AND SHALL COMP, IT WITH THE TREMS AND COMPLITY OF THE DETERMINATIONAL POLICIANT OND CARRES EMBRACION. SOTE IN THE DESCRIPTION TO THE ORDER OF THE STREET OF THE STREET

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1	WEIGHT AVELO	PHONE	
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ı	NAME	ADDRESS	ENTRANCE, EARTH DIKES SEDIMENT BASIN
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1		PHONE	

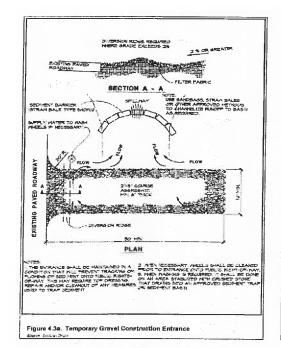
MAIN STREET LANDING NPDES STORMWATER MANAGEMENT PLAN

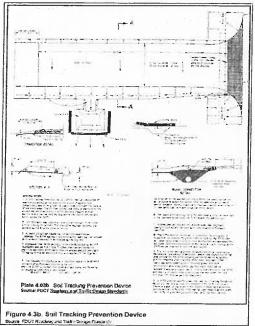
THE NPUES CONTRACTOR AND INJECONTRACTOR CERTIFICATION TO BE COMPETED AFTER

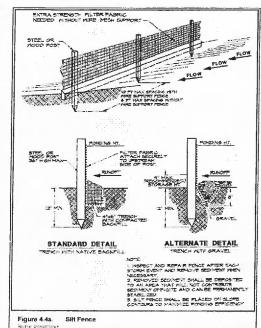
NEW PORT RICHE!		r_nail
PREPARED FOR	SATE	(AFFROVEC 9Y
Main Street Landing, LLP P.O. BOX 2900	DEG (AS)	APPROVERS INFORMATION HERE
Gainesville, FL 32602-290 (352) 372-6172	SCALE	
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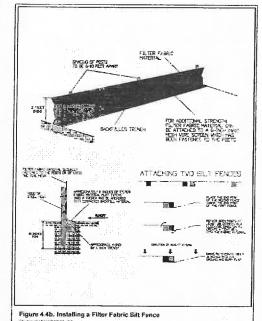
RING ENGINEERING, INC.	SHEET 1 OF 2
and the same of th	1
CONTRACTOR	1000

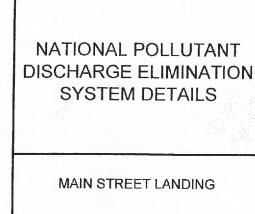
ALL CONSTRUCTION TRAFFIC AND EQUIPMENT SHALL ACCESS THE SITE USING THE EXISTING PARKING NOT DRIVEWAYS, NEXCATED ABOVE











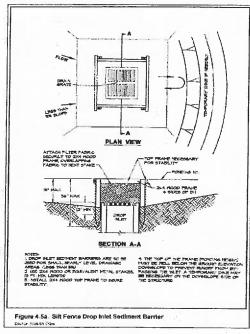
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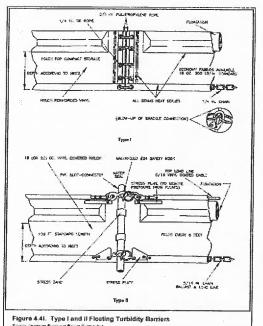
SHEET 2 OF 2

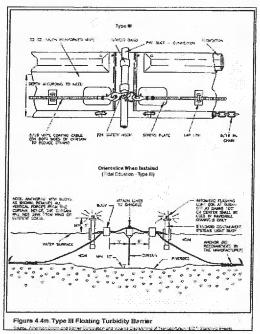
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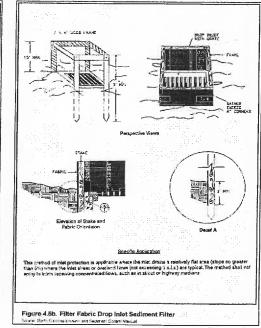
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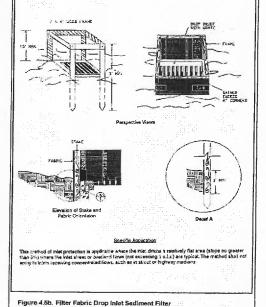
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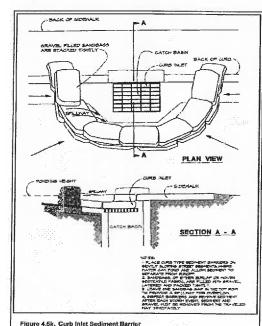


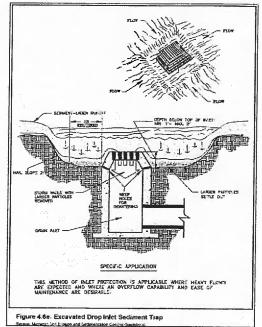


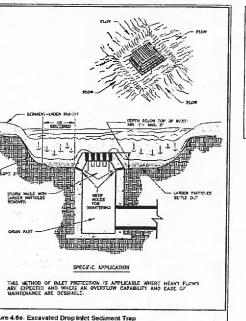


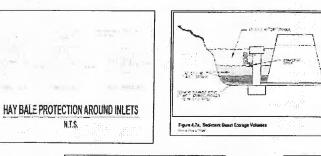


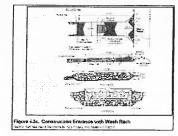


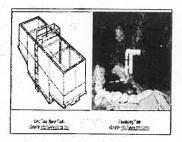


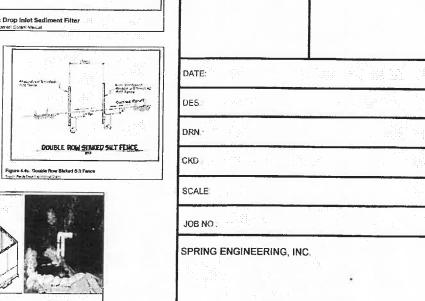










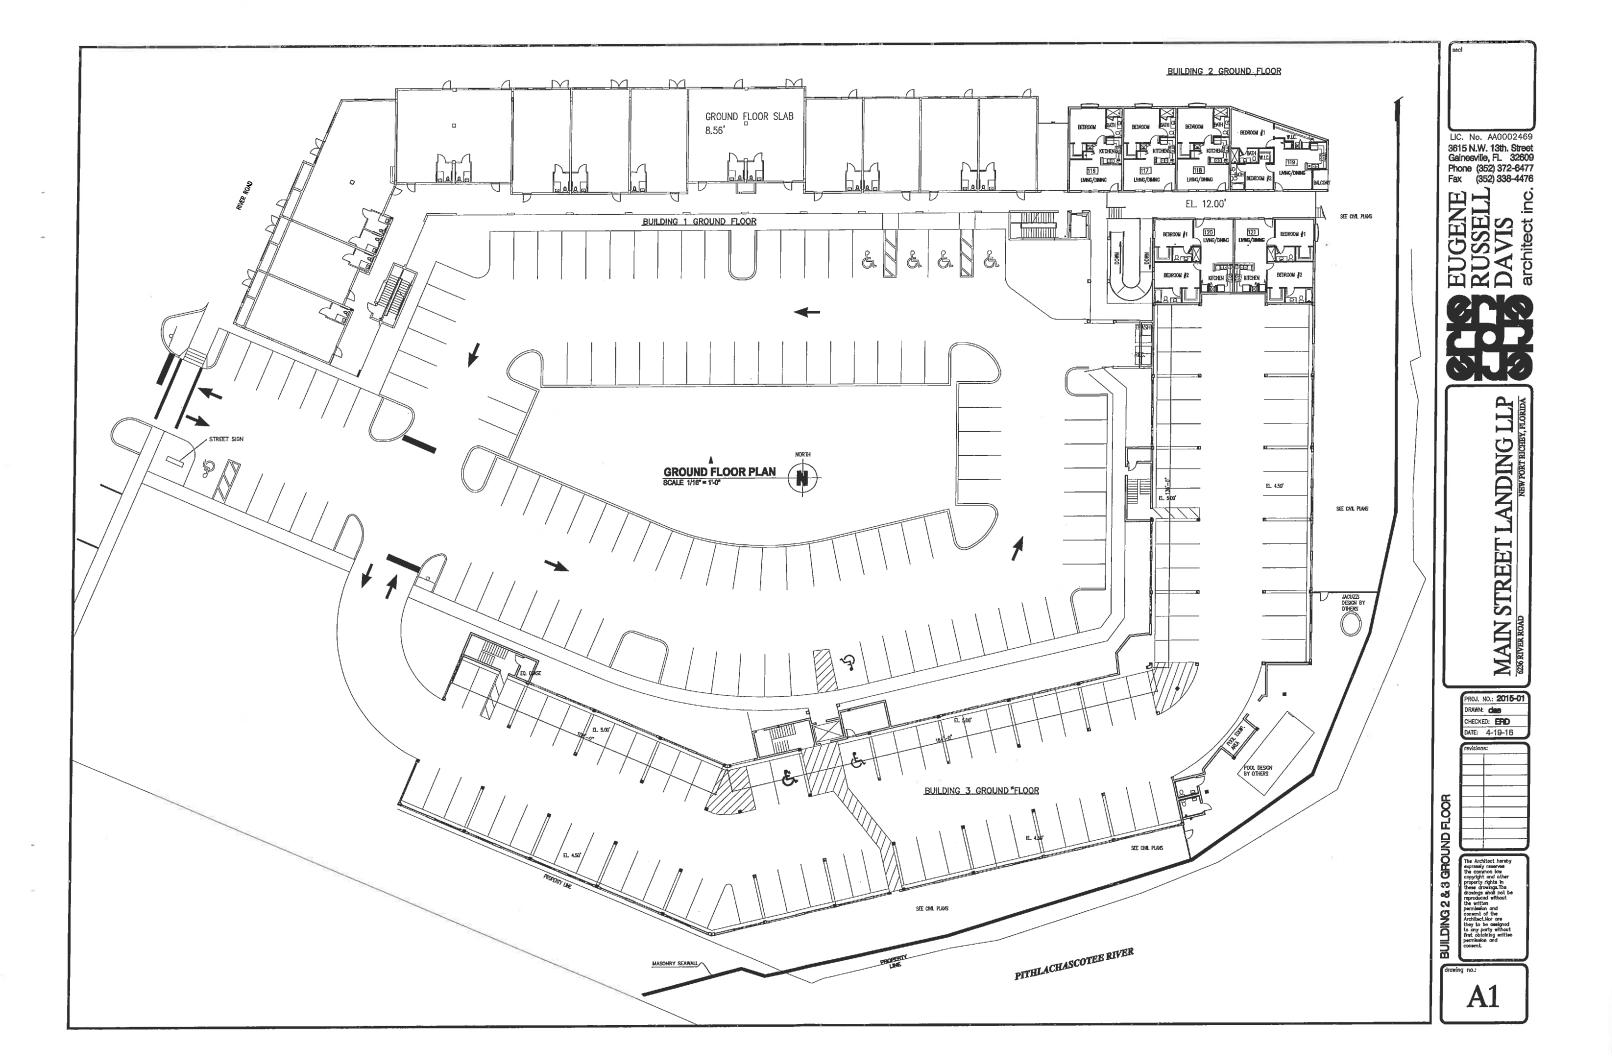


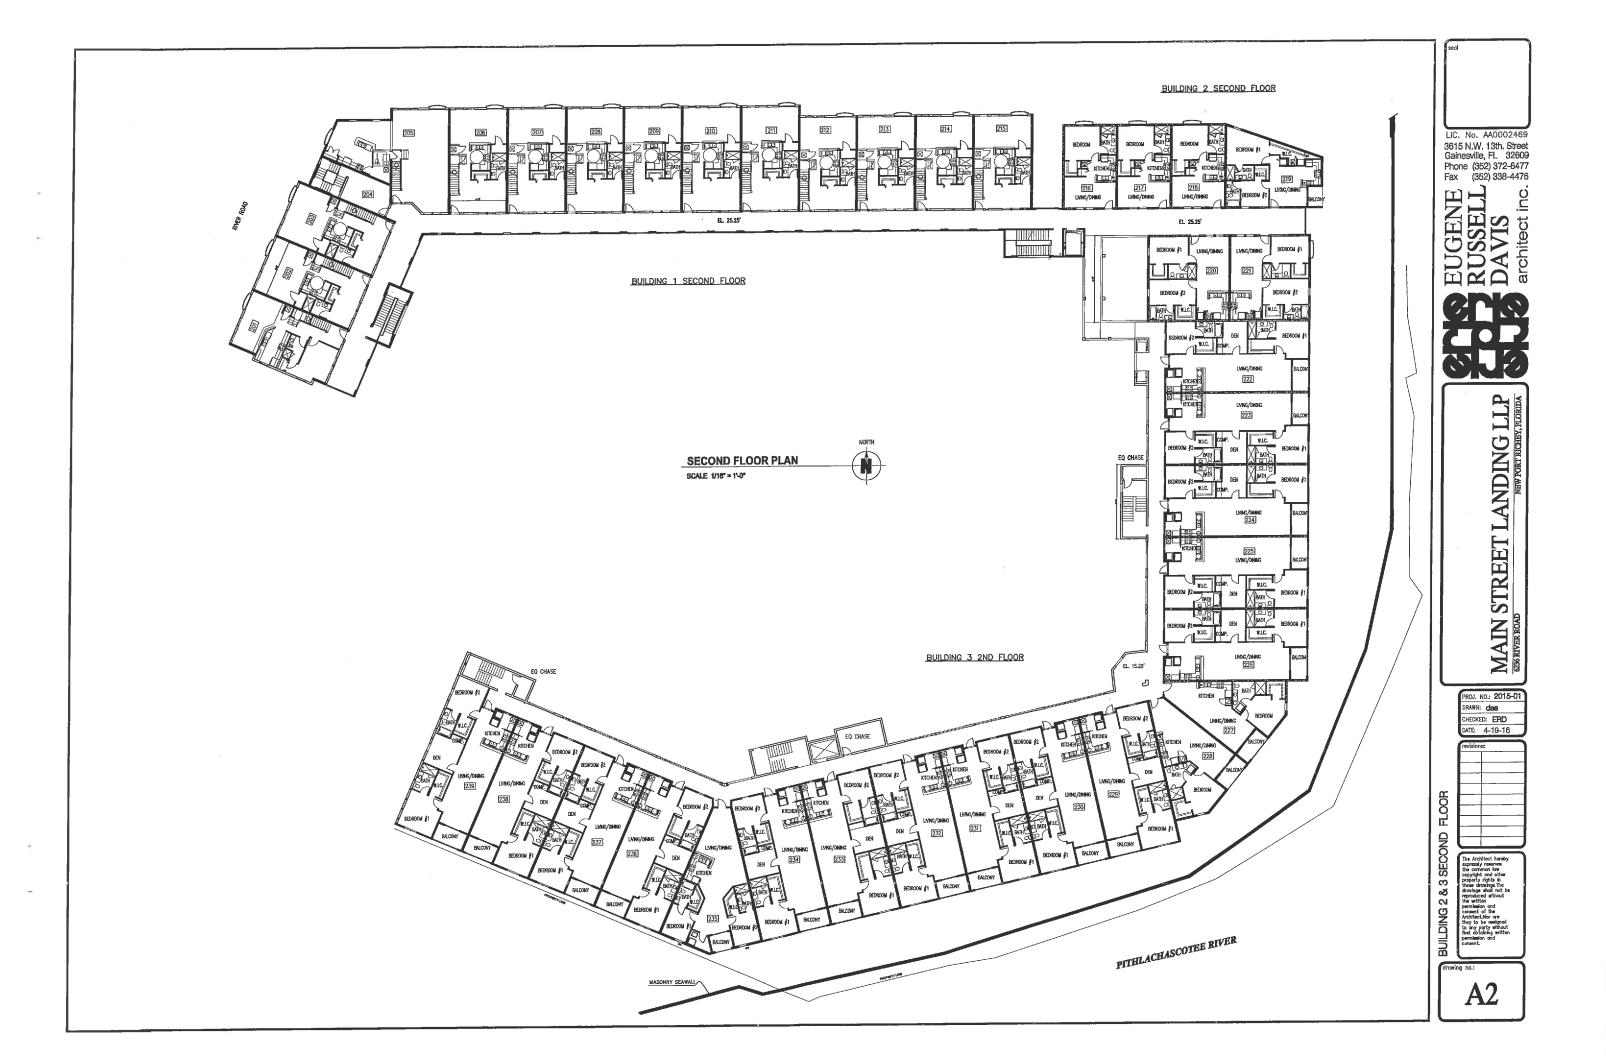
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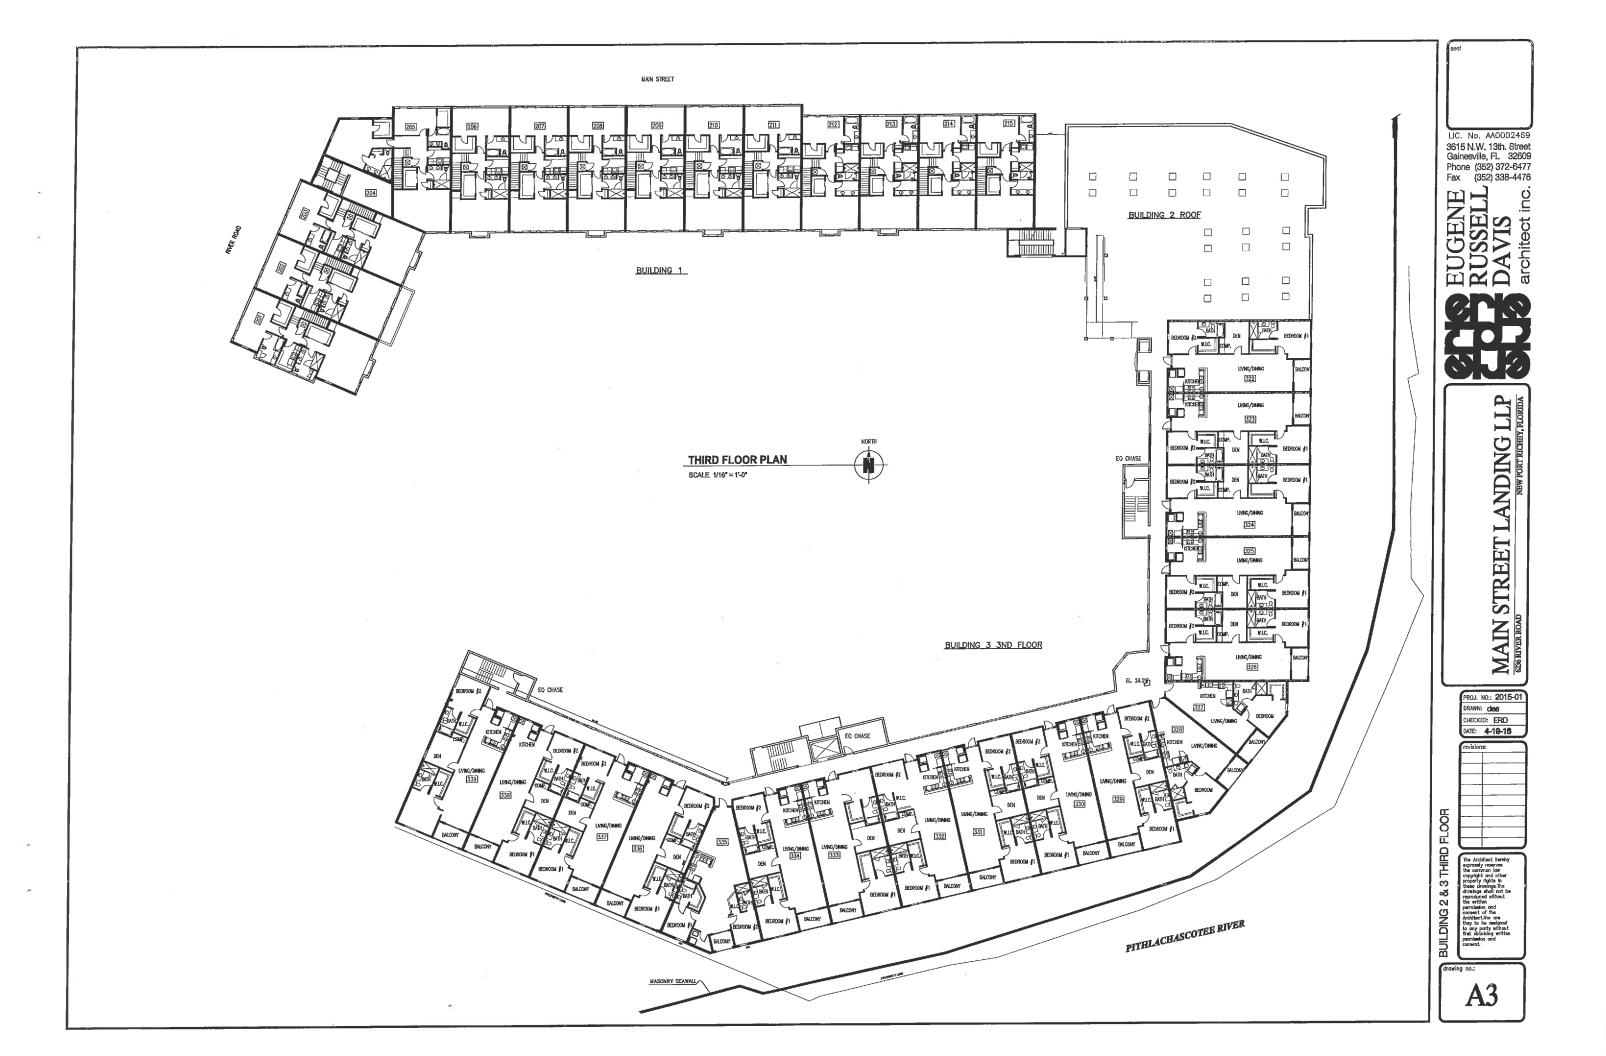
P.O. Box 2900

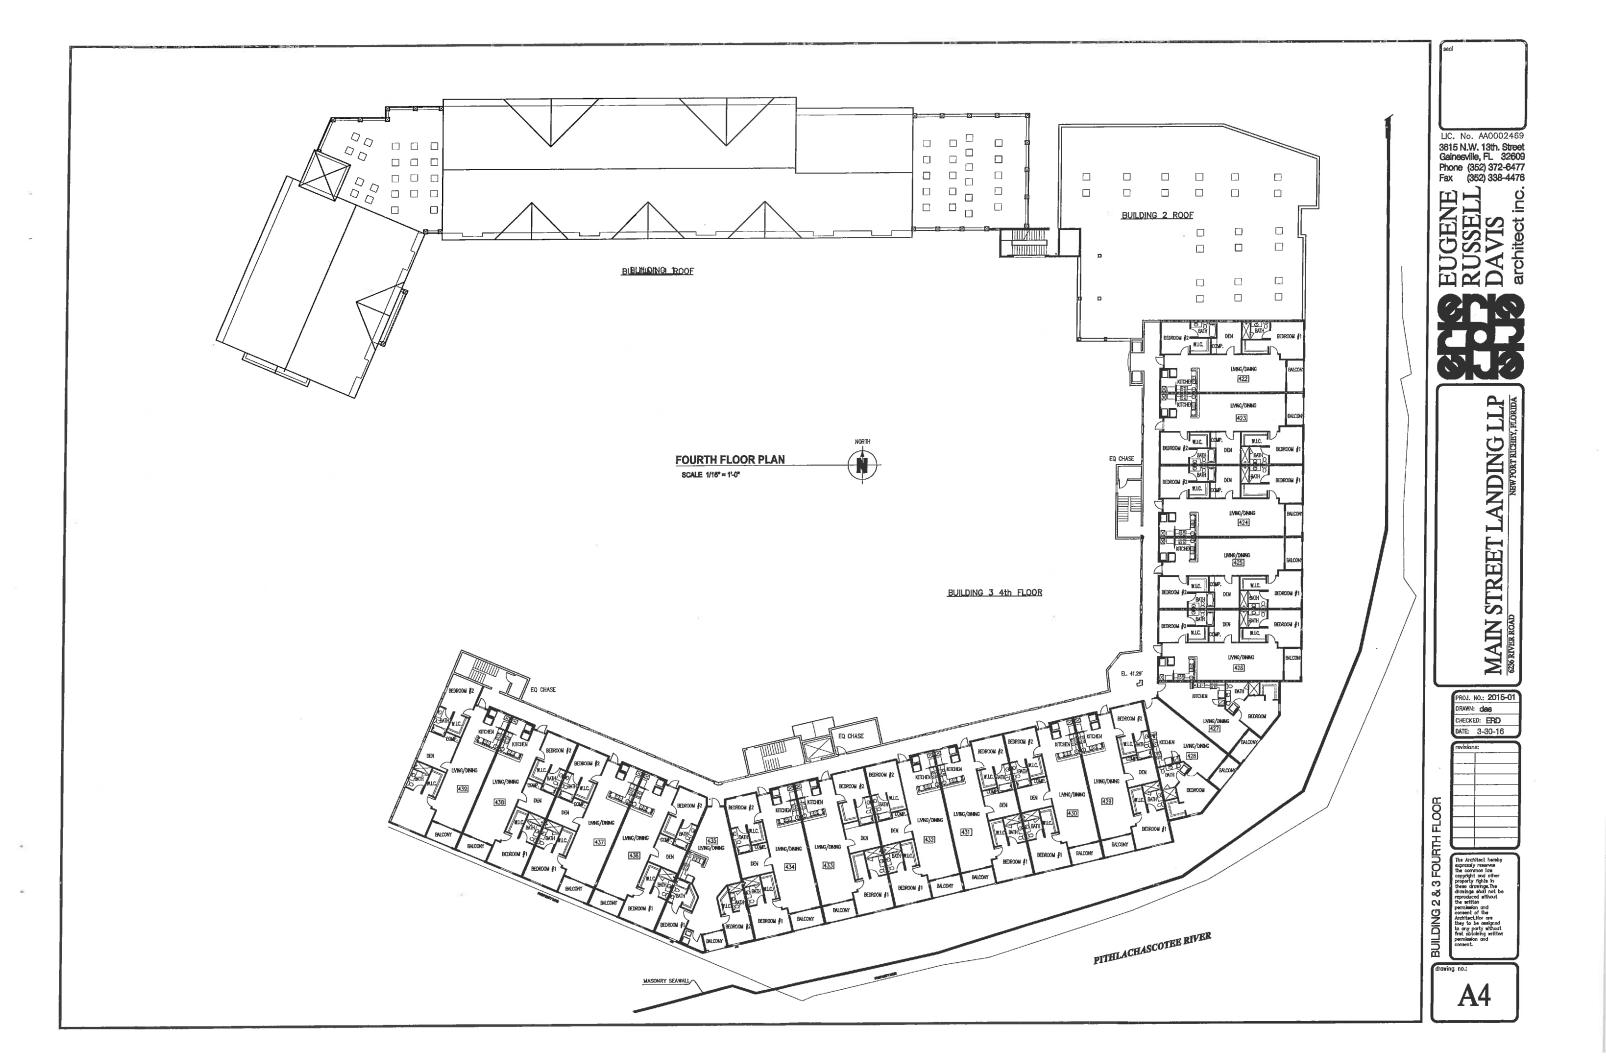
Main Street Landing, LLP

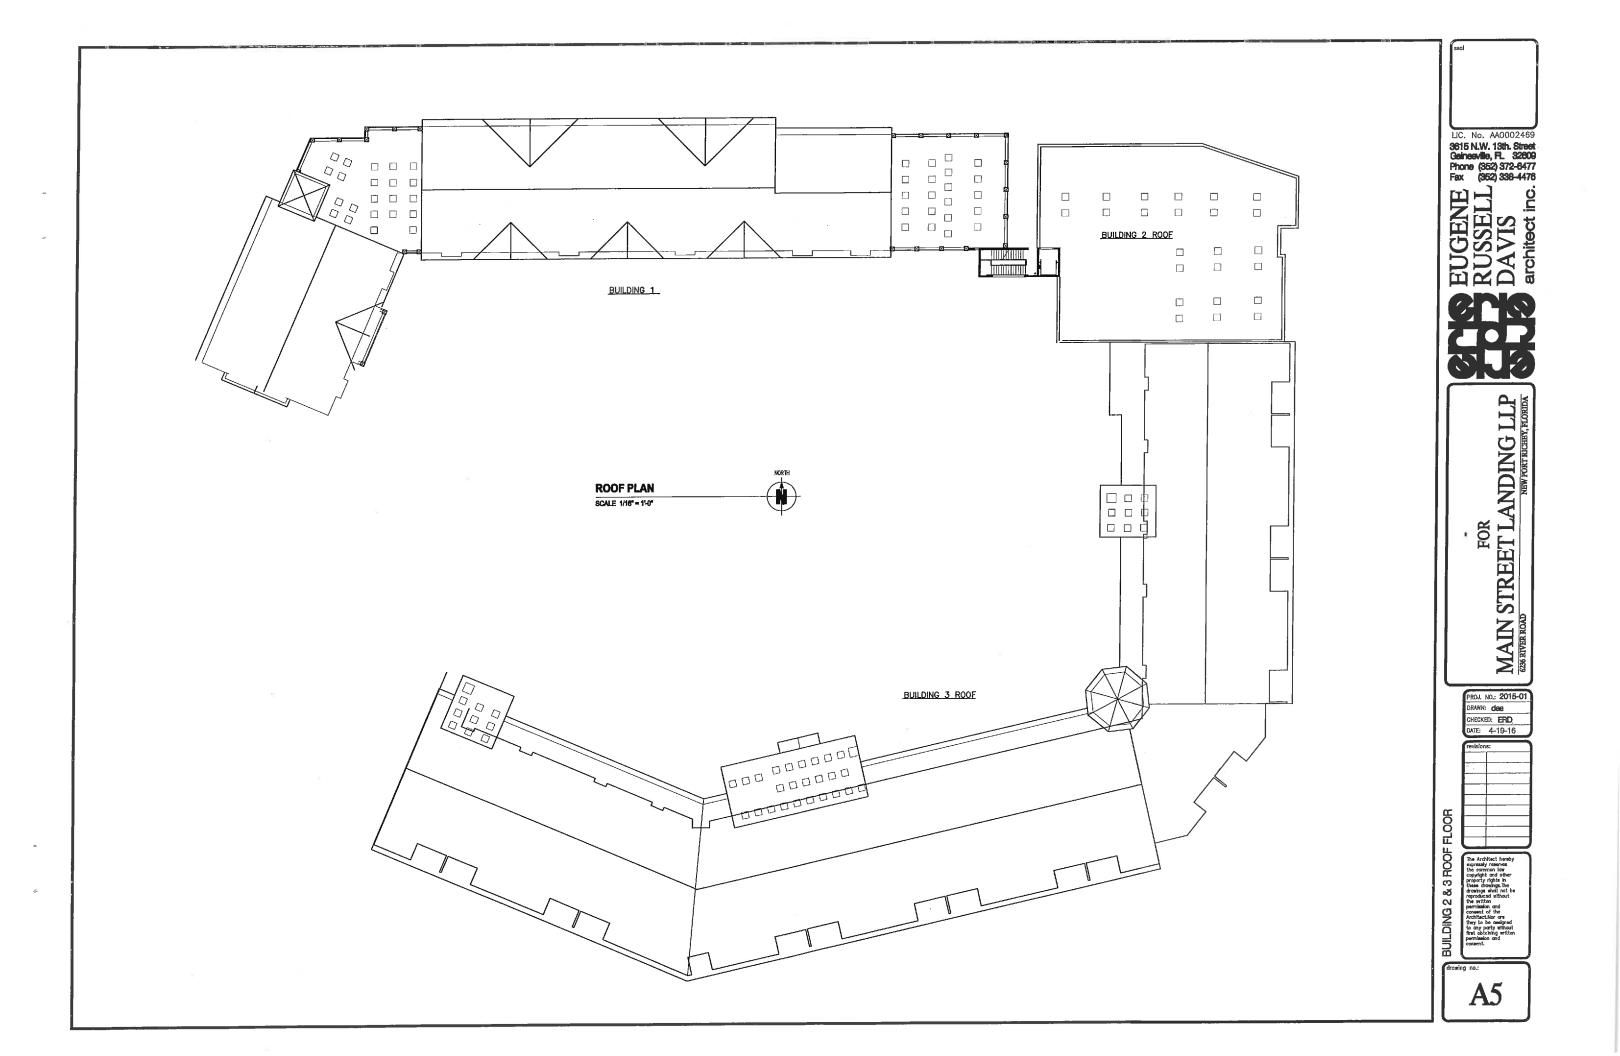
Gainseville, FL 32602-2900 (352) 372-6172

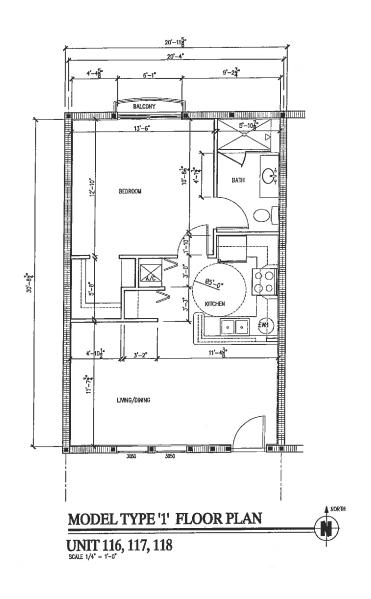




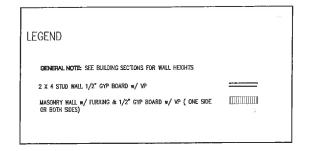


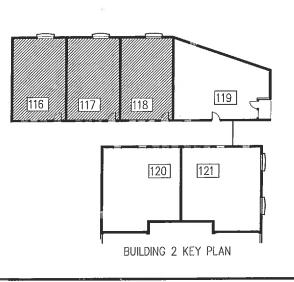






COND. AREA = 651 SF





LIC. No. AA0002469

ECCEPTE No. AA0002469
3615 N.W. 13th. Street
Gainesville, FL 32609
Phone (352) 372-6477
Fax (352) 338-4476

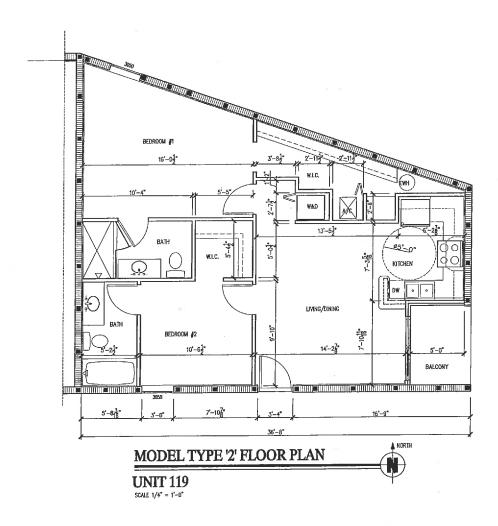
architect i.u.c.

MAIN STREET LANDING LLP

PROJ. NO.: 2015-01 DRAWN: clas CHECKED: ERD DATE: 4-19-16

BUILDING 2 - UNIT TYPE '1' FLOOR PLAN The Architect hereby expressly reserves the common low copylight and other property of physics. The common low copylight and other property of physics. The development of the property of the property of the property of the consent of the copy of the property without first obtaining written permission and consent.

A6



GROSS AREA = 950 SF COND. AREA = 908 SF

> 119 116 117 118 120 121 BUILDING 2 KEY PLAN

LIC. No. AA0002469 3615 N.W. 13th. Street Gainesville, FL. 32609 Phone (352) 372-6477 Fax (352) 338-4476

EUGENE RUSSELL BAVIS
DAVIS architect inc.



MAIN STREET LANDING LLP

PROJ. NO.: 2015-01 DRAWN: des CHECKED: ERD
DATE: 4-19-16

BUILDING 2 - UNIT TYPE '2' FLOOR PLAN

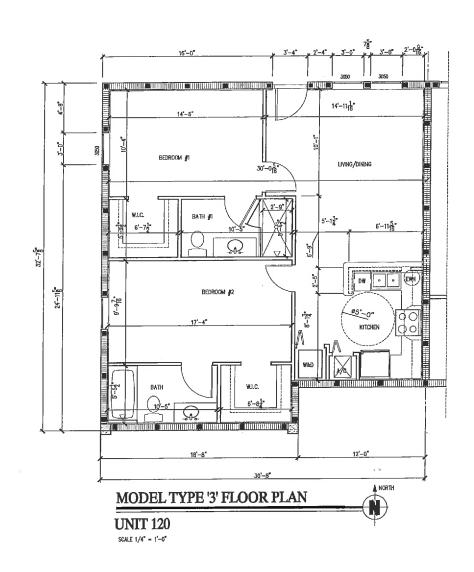
LEGEND

GENERAL NOTE: SEE BUILDING SECTIONS FOR WALL HEIGHTS

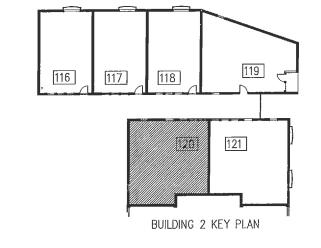
2 X 4 STUD WALL w/ R-13 MISUL & 1/2" GYP BOARD w/ VP

2 X 6 STUD WALL w/ R-19 INSUL & 1/2" GYP BOARD w/ VP

MASCHRY WALL w/ FURRING & 1/2" GYP BOARD w/ VP (ONE SIDE OR BOTH SIDES)



GROSS AREA = 942 SF



LIC. No. AA0002469 3615 N.W. 13th. Street Geineeville, FL 32609 Phone (352) 372-6477 Fax (352) 338-4476 EUGENE REUSSELL BOAVIS RECHIECT INC. FOR MAIN STREET LANDING
6206 RIVER ROAD
NEW PORT RUGHES

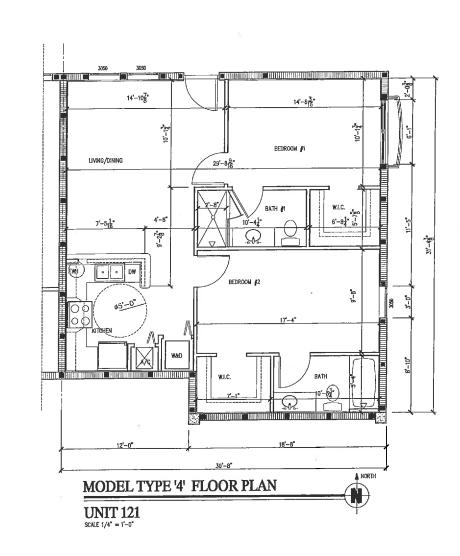
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DATE: 4-19-16 BUILDING 2 - UNIT TYPE 3' FLOOR PLAN

LEGEND

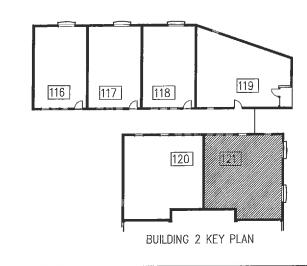
GENERAL NOTE: SEE BUILDING SECTIONS FOR WALL HEIGHTS

2 X 4 STUD WALL w/ R-13 INSUL & 1/2" GYP BOARD w/ YP

MASONRY WALL w/ FURRING & 1/2" GYP BOARD w/ VP (ONE SIDE INTERPRETATION OR BOTH SIDES)



GROSS AREA = 950 SF COND. AREA = 942 SF



LIC. No. AA0002469 3615 N.W. 13th. Street Gainesville, FL 32609 Phone (352) 372-6477 Fax (352) 338-4476

RUSSELL (SE) DAVIS architect inc. 92474

MAIN STREET LANDING LLP

PROJ. NO.: 2015-01 DRAWN: das
CHECKED: ERD
DATE: 4-19-16

BUILDING 2 - UNIT TYPE '4'

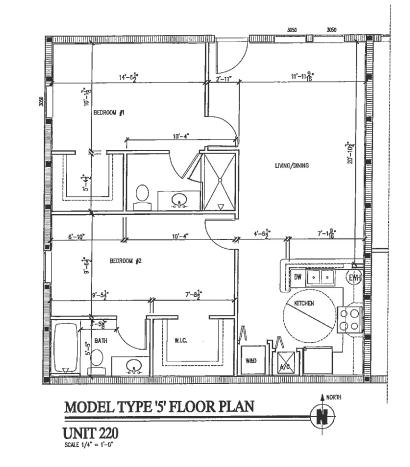
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LEGEND

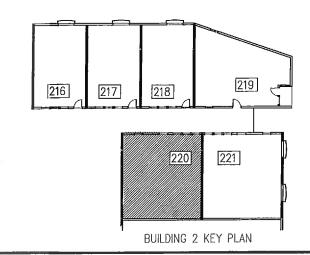
GENERAL NOTE: SEE BUILDING SECTIONS FOR WALL HEIGHTS

2 X 4 STUD WALL w/ R-13 INSUL & 1/2" GYP BOARD w/ VP

MASONRY WALL W/ FURRING & 1/2" GYP BOARD W/ VP (ONE SIDE UNDES)



GROSS AREA = 992 SF



LIC. No. AA0002469 3615 N.W. 13th. Street Gainesville, FL 32609 Phone (352) 372-6477 Fax (352) 338-4476

EUGENE XELL (25)

BAVIS

architect inc. 24,74

MAIN STREET LANDING LLP
625 RIVER ROAD
NEW PORT RICHEN, FLORIDA

PROJ. NO.: 2015-01

DRAWN: des CHECKED: ERD DATE: 4-19-16

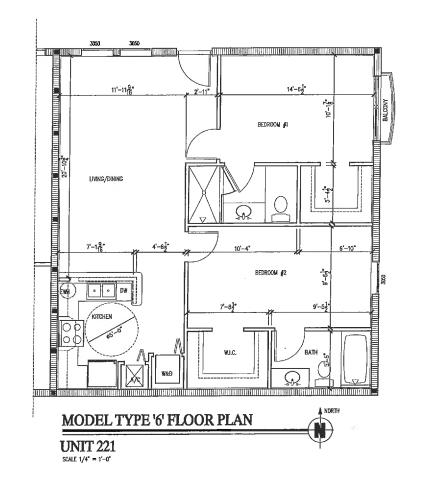
LEGEND

GENERAL NOTE: SEE BUILDING SECTIONS FOR WALL HEIGHTS

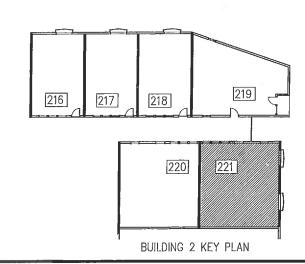
2 X 4 STUD WALL w/ R-13 INSUL & 1/2" GYP BOARD w/ VP

MASONRY WALL w/ FURRING & 1/2" GYP BOARD w/ VP (ONE SIDE () OR BOTH SIDES)

LEGEND **GENERAL NOTE:** SEE BUILDING SECTIONS FOR WALL HEIGHTS 2 X 4 STUD WALL w/ R-13 INSUL & 1/2" GYP BOARD w/ VP (2)2 X 4 STUD WALL w/ R-19 INSUL & 1/2" GYP BOARD w/ VP MASONRY WALL w/ FURRING & 1/2" GYP BOARD w/ VP (ONE SIDE OR BOTH SIDES)



GROSS AREA = 1000 SF COND. AREA = 992 SF



LIC. No. AA0002469

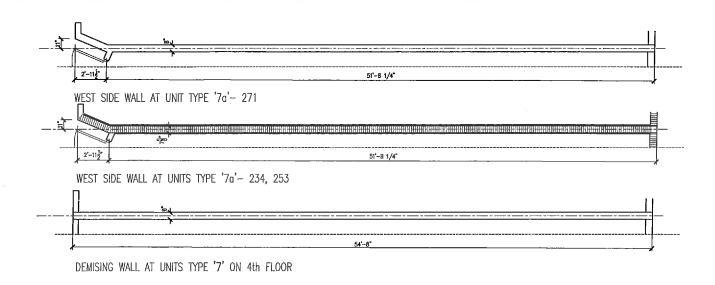
ROSELLE No. A40002469
S615 N.W. 13th. Street
Gaineeville, FL 32609
Phone (352) 372-6477
Fax (352) 338-4476

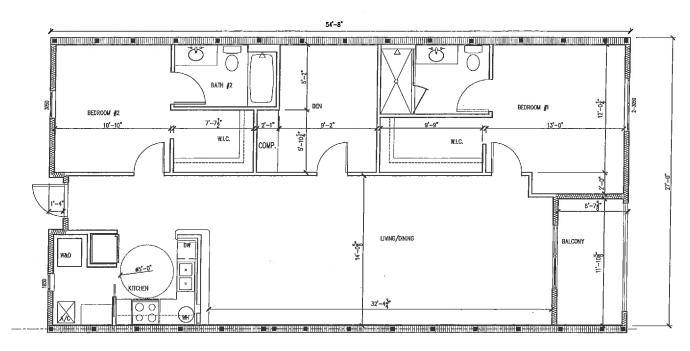
architect inc.

FOR MAIN STREET LANDING LLP 6256 RIVER ROAD NEW PORT RICHEY, R. ONDA

PROJ. NO.: 2015-01 DRAWN: des

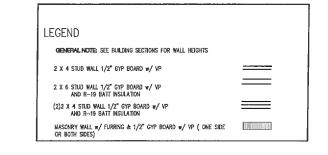
CHECKED: ERD
DATE: 4-19-16 BUILDING 2 - UNIT TYPE '8' FLOOR PLAN







GROSS AREA = 1470 SF COND. AREA = 1389 SF



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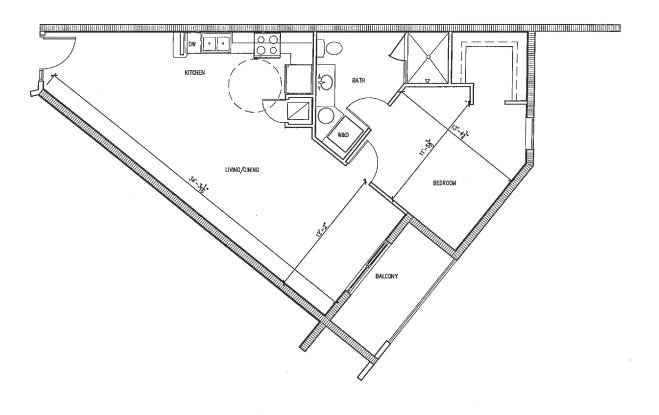
EUGENE RUSSELL BOAVIS

architect inc.

FOR MAIN STREET LANDING LLP 6226 RIVER ROAD NOW PORT RICHEST, FLORIDA

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DATE: 4-19-16

BUILDING 3 - UNIT TYPE 7' FLOOR PLAN



MODEL TYPE '8' FLOOR PLAN SCALE 1/4" = 1'-0" UNIT 227

GROSS AREA = 922 SF COND. AREA = 851 SF

RUSSELLE No. VA00057469

RUSSELLE No. VA00057469

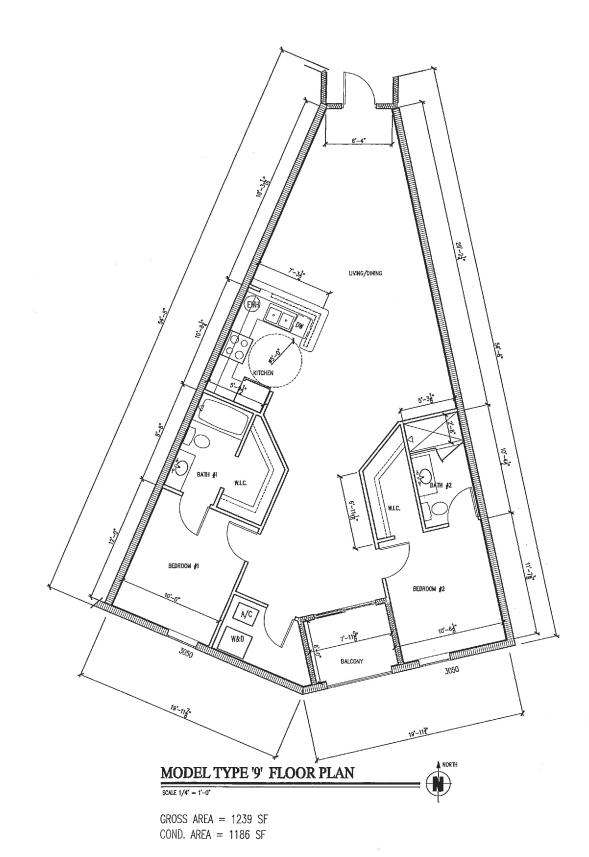
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HOR MAIN STREET LANDING LLP 626 RIVER ROAD NEW PORT RICHEY, FLOREDA

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BUILDING 3 - UNIT TYPE '8' REV. FLOOR PLAN



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BUILDING 3 - UNIT TYPE '9' FLOOR PLAN

BUILDING 3 KEY PLAN



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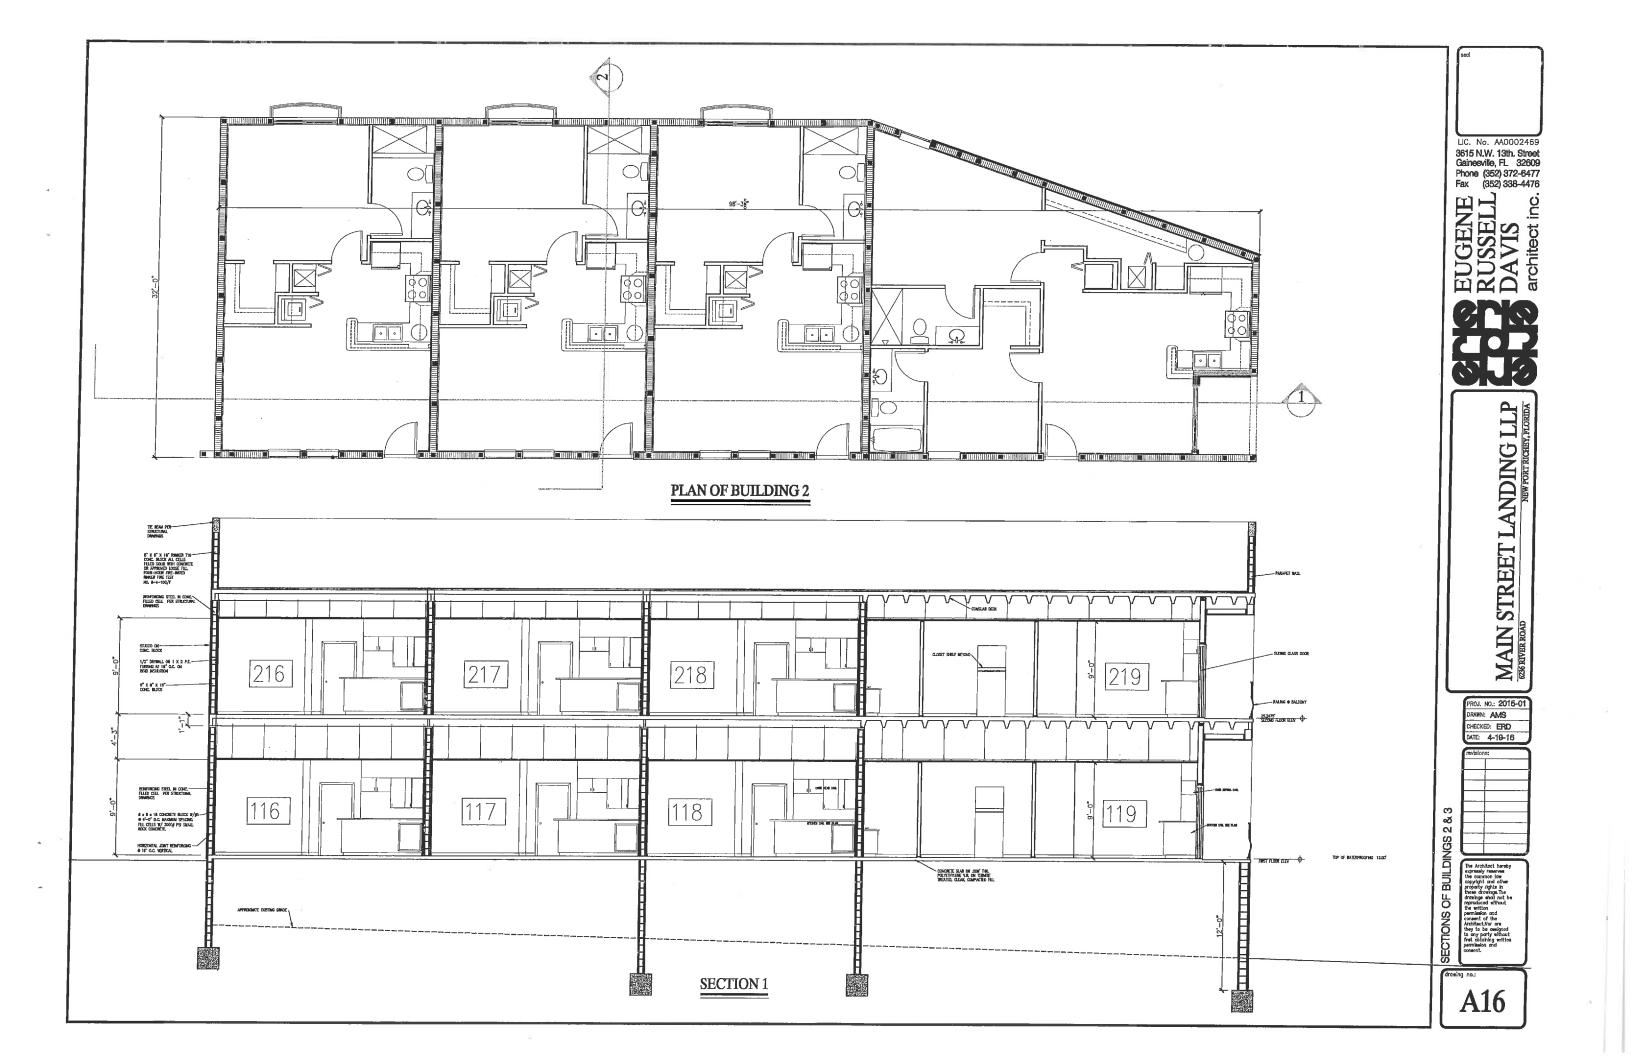
Fax (352) 338-4476

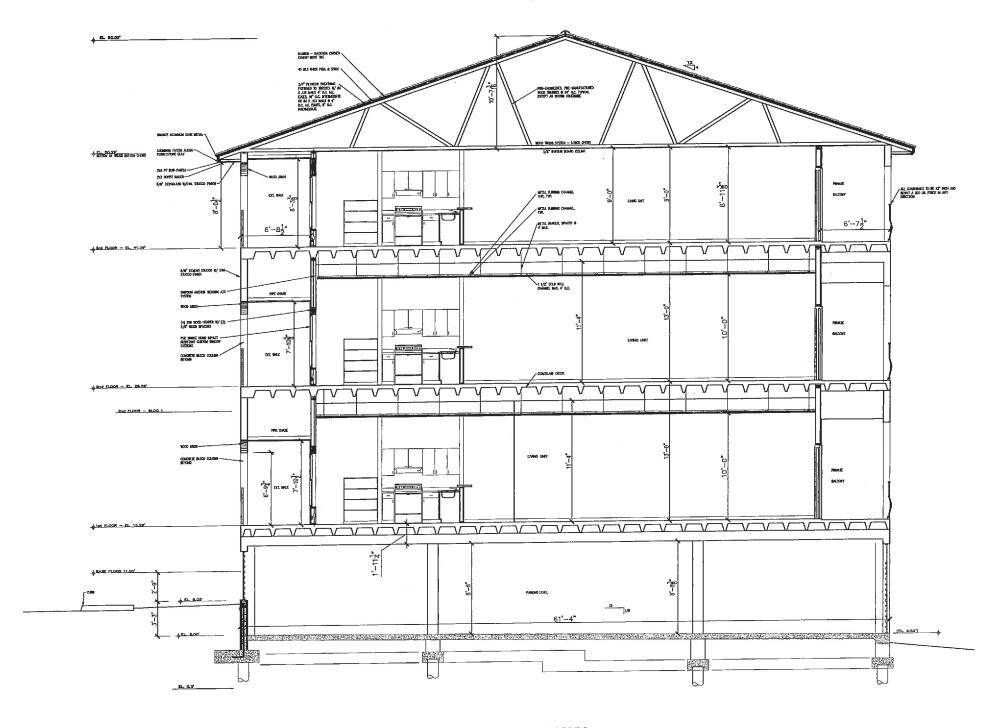
HAIN STREET LANDING LLP

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BUILDING 3 - UNIT TYPE '10' FLOOR PLAN

A15





SECTION 3

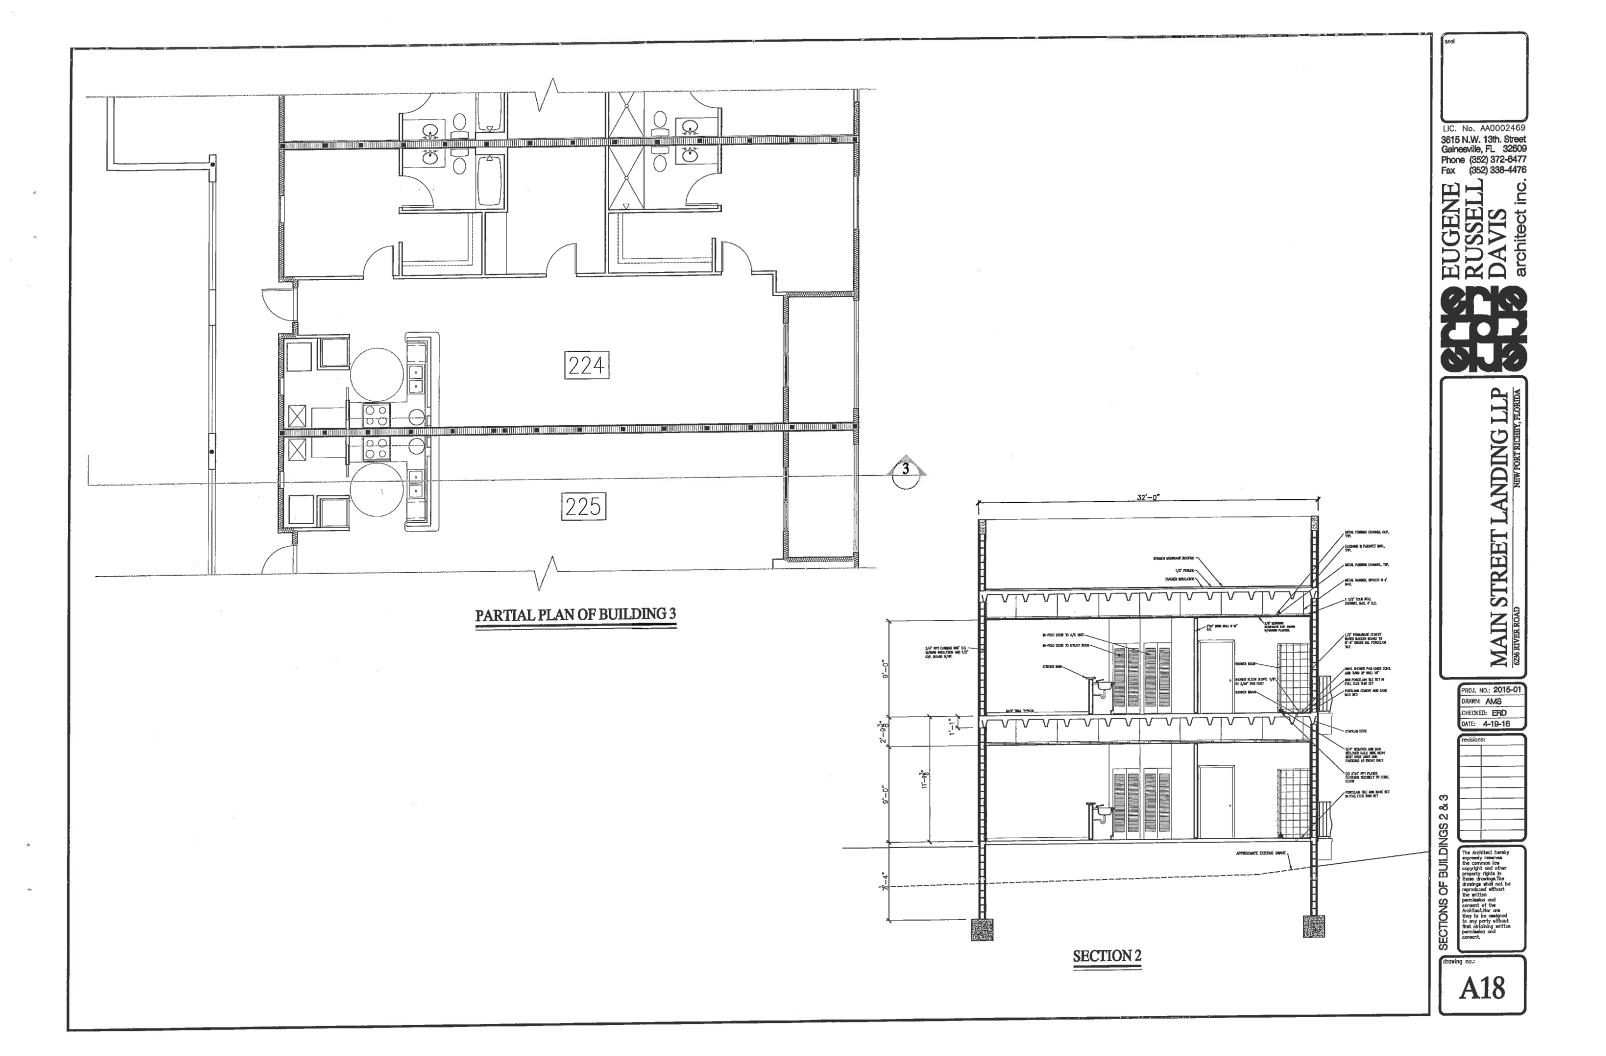
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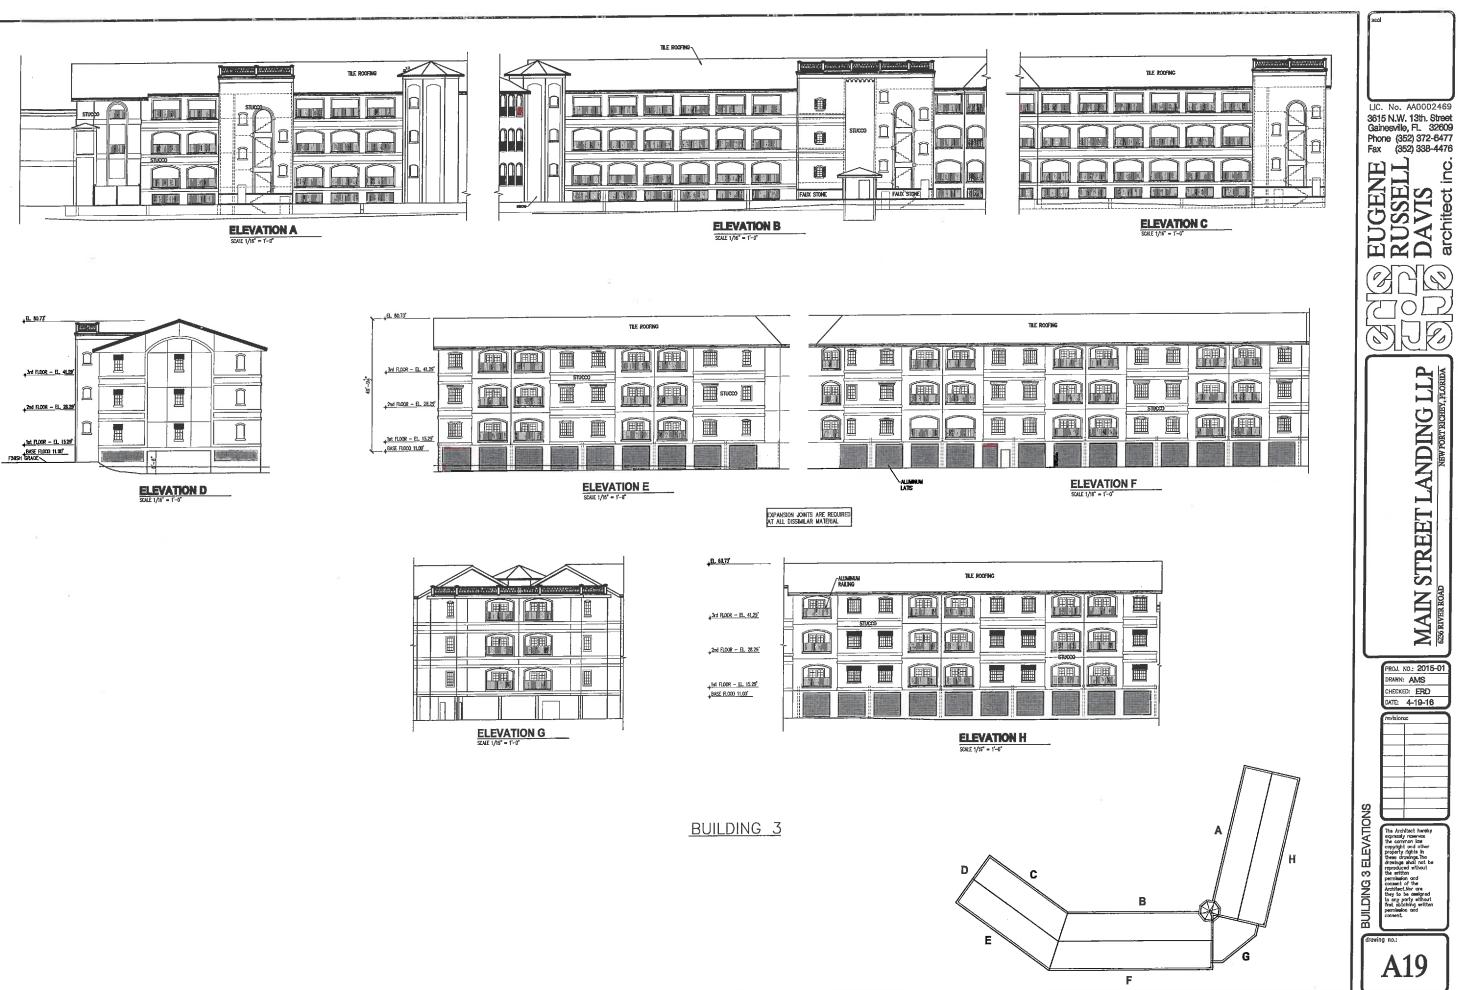
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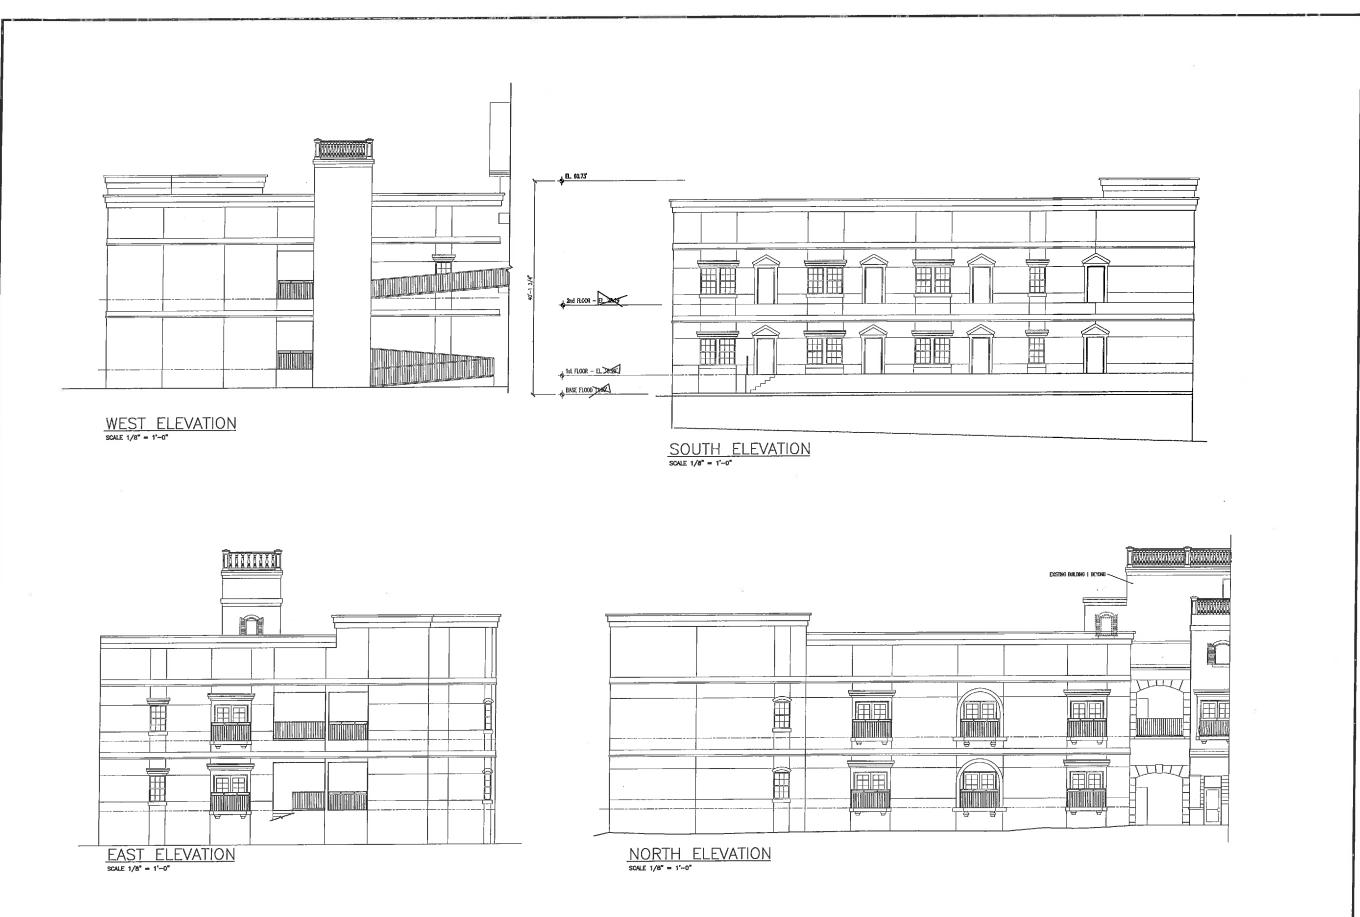
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BUILDING 2

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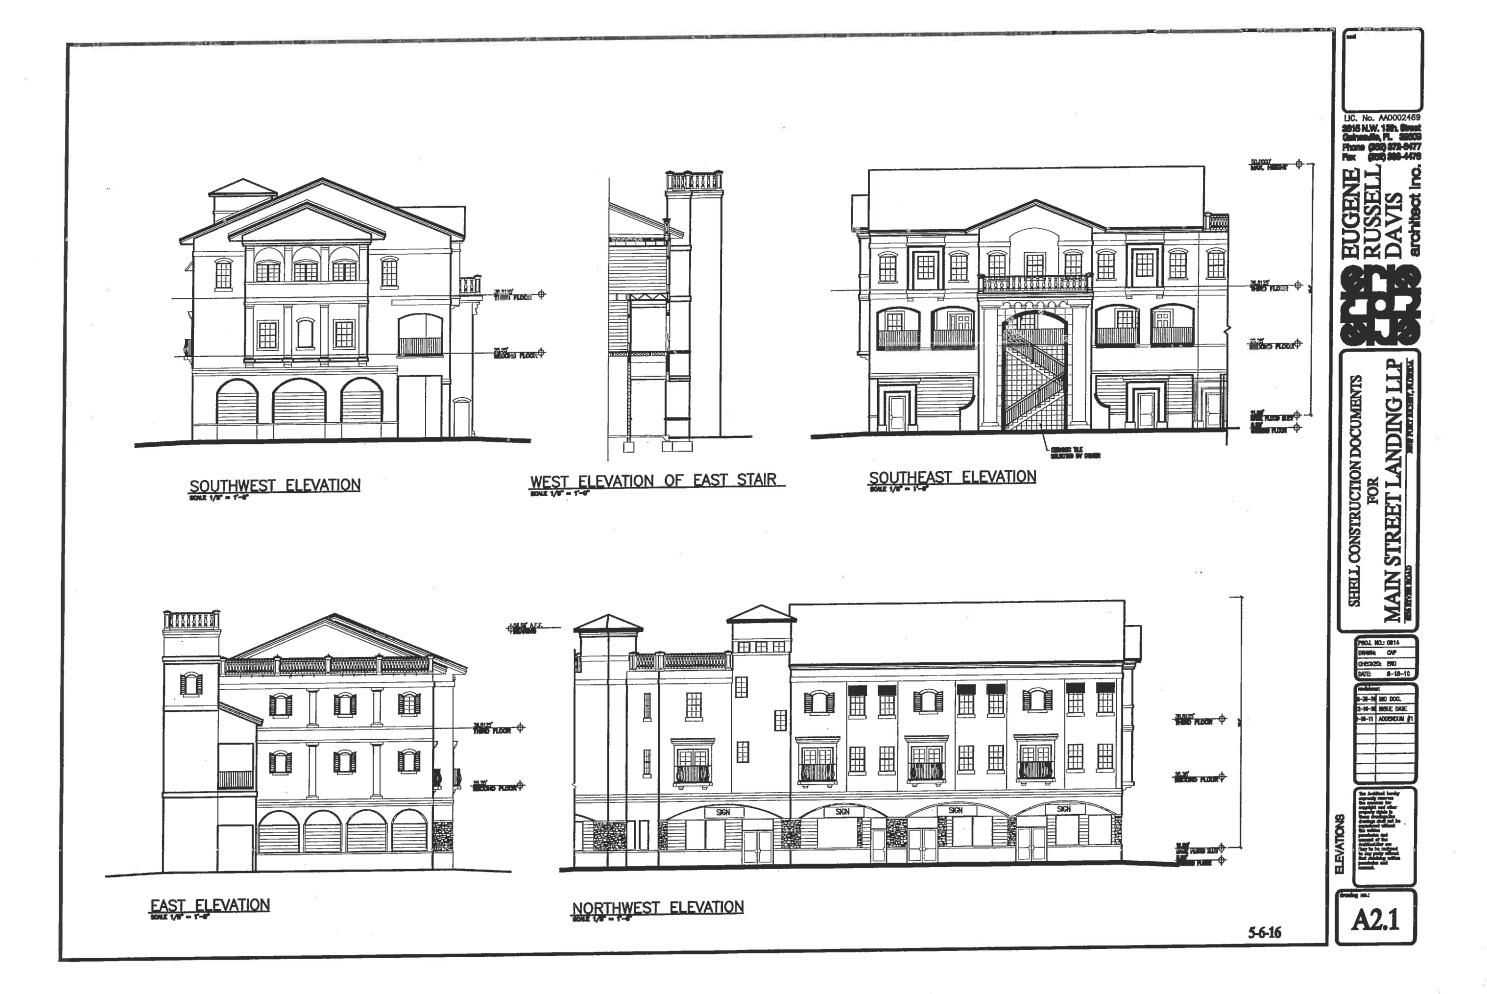
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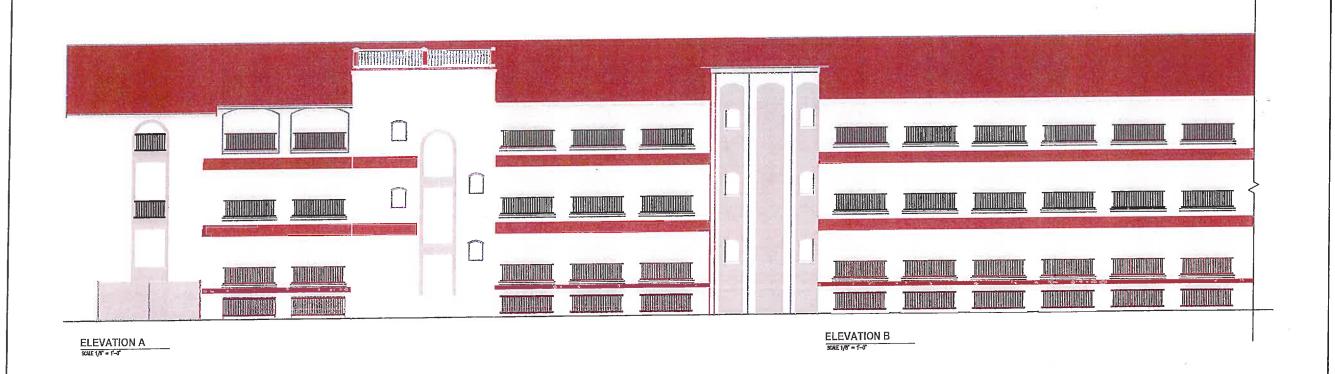
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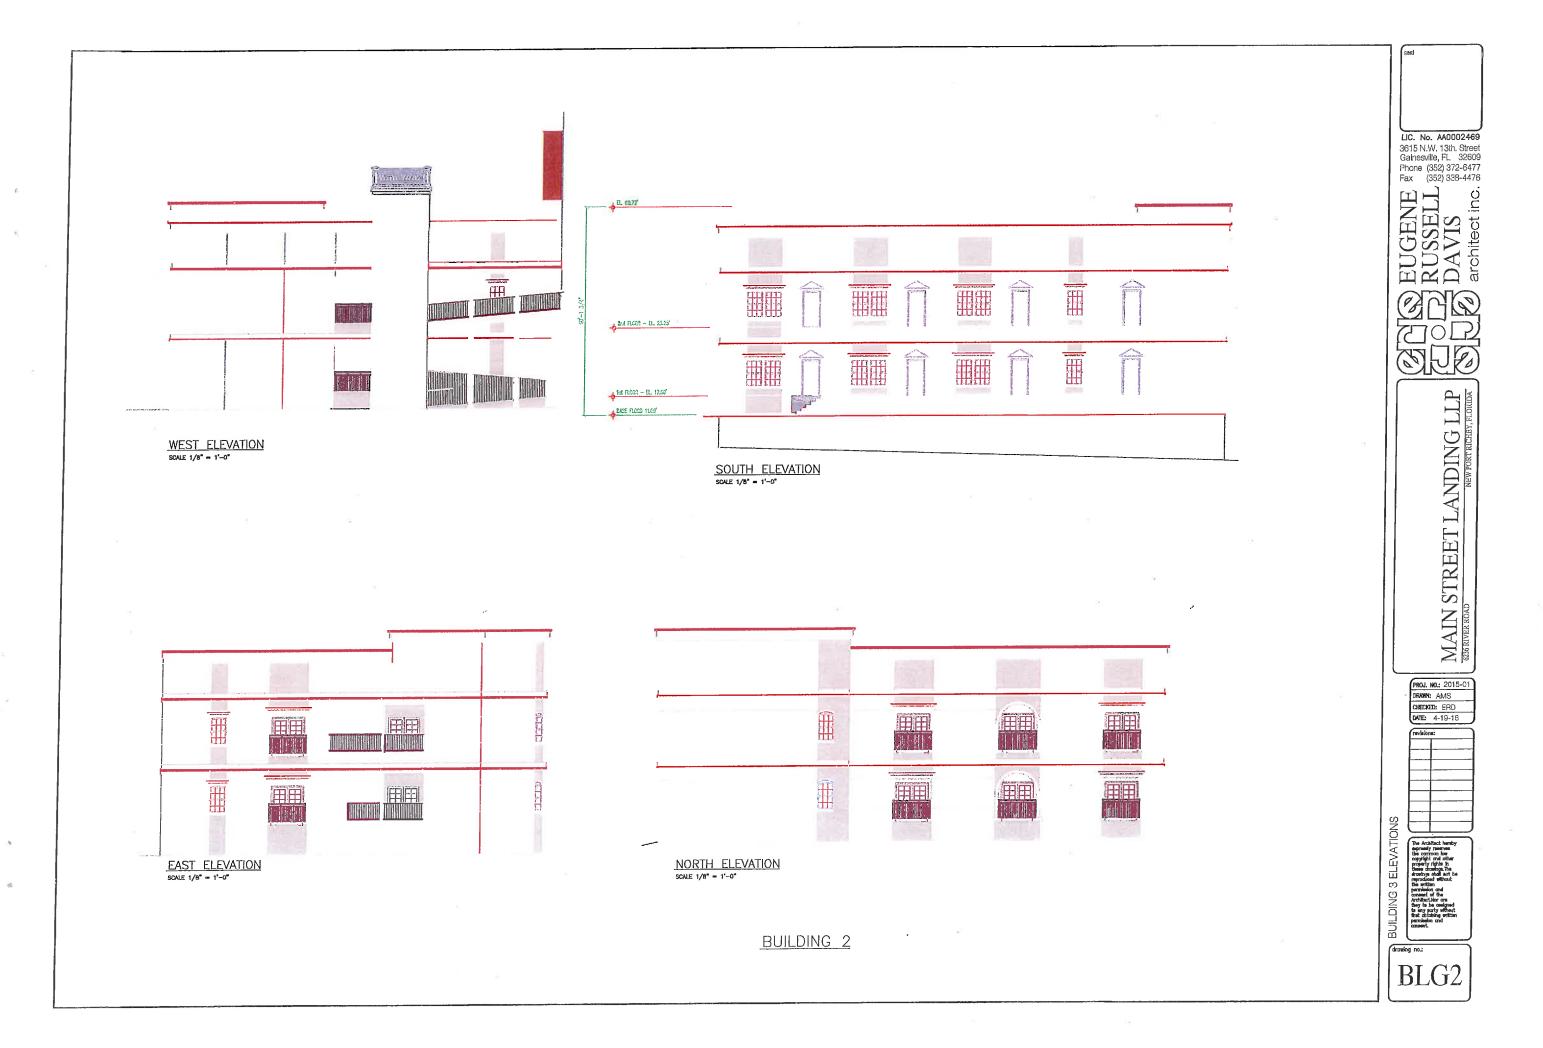
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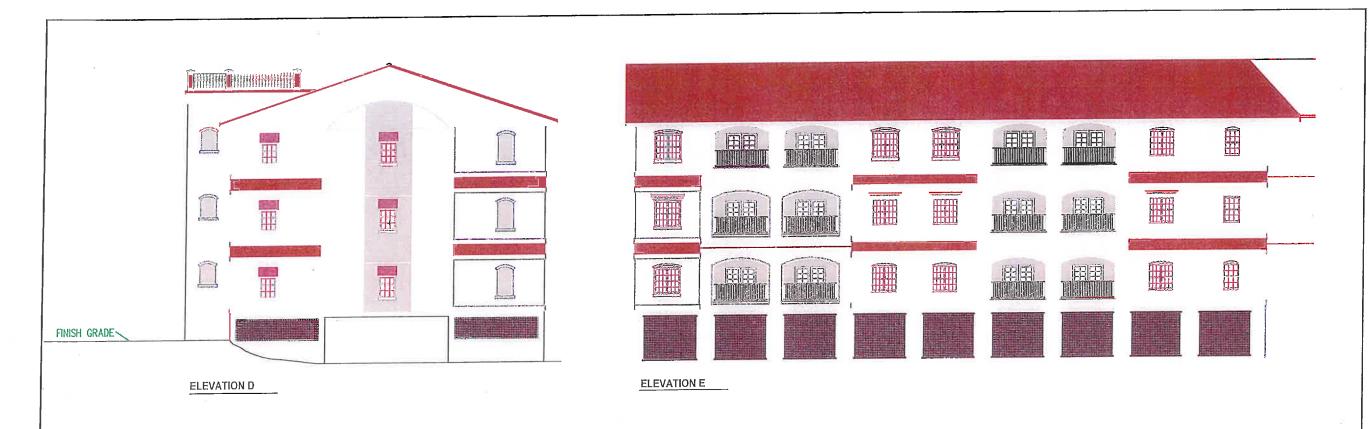
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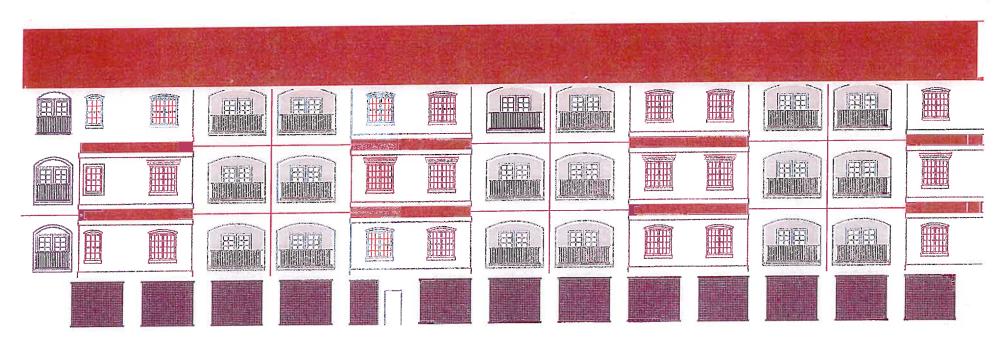
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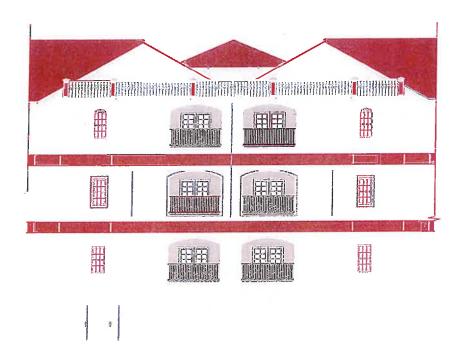
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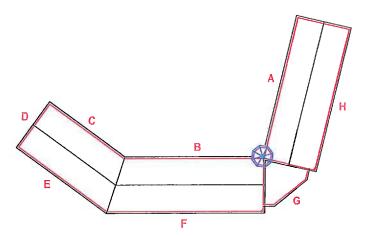
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EUGENE RUSSELL DAVIS architect inc.

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